DOCUMENTATION OF CIVIL WORKS


NEW DEVELOPMENT

1A QUEEN STREET AUBURN

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STORMWATER SECTIONS & DETAILS SHEET

CIVIL DRAWING LIST

REFERENCE DOCUMENTS
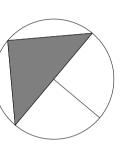
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STORMWATER NOTES

- SW1. STORMWATER DRAINS TO BE RUN TO SUIT THE LOCAL SEWERAGE AND DRAINAGE BOARD, FROM THE STORMWATER DRAINS WITH PIPES AND FITTINGS SET NOT LESS THAN MINIMUM FALLS RECOMMENDED BY THE GOVERNING AUTHORITY, WITH MATERIALS AND LEVELS SHOWN ON THE DRAWINGS AND IN THE SPECIFICATION.
- SW2. ALL PIPES SHALL BE UPVC 100mm DIAMETER U.N.O. IN ACCORDANCE WITH AS3500.3 NATIONAL PLUMBING AND DRAINAGE CODE, PART 3: STORMWATER
- SW3. ALL PIPES TO BE UPVC OR CONCRETE AS NOTED AND IN ACCORDANCE WITH AS3500.3 NATIONAL PLUMBING AND DRAINAGE CODE, PART 3: STORMWATER
- SW4. ALL UPVC PIPES TO BE INSTALLED IN ACCORDANCE
- WITH AUSTRALIAN STANDARD AS2032. SW5. ALL PIPES SHALL BE LAID AT A MINIMUM GRADE OF 1 IN 100 U.N.O.
- SW6. ARROWS INDICATE THE DIRECTION OF GRADE. SW7. ALL FOOTPATH AND DRIVEWAY CROSSINGS SHALL BE TO LOCAL COUNCIL REQUIREMENTS.
- SW8. ALL LEVELS ARE APPROXIMATE ONLY AND SHALL
- BE CONFIRMED PRIOR TO CONSTRUCTION. SW9. ALL EXISTING LEVELS ARE SHOWN AS A SPOT LEVEL OR A CONTOUR WITHOUT ANY PREFIX OR
 - DESCRIPTION. LEVEL DESCRIPTIONS ARE AS FOLLOWS; FL - FLOOR LEVEL
- SL SURFACE LEVEL
- IL INVERT LEVEL ALL LEVELS ARE TO AUSTRALIAN HEIGHT DATUM
- SW10. MINIMUM COVER TO UPVC STORMWATER PIPES SHALL BE; TRAFFICABLE AREAS - 450 mm LANDSCAPE AREAS - 300 mm COVER IS MEASURED VERTICALLY FROM THE TOP OF
- THE PIPE TO THE FINISHED SURFACE LEVEL. PIPES TO BE PROTECTED BY CONCRETE **ENCASEMENT TO ENGINEERS APPROVAL IF MINIMUM**
- COVER CANNOT BE ACHIEVED. SW11. CONNECTION OF UPVC TO PRECAST PITS TO BE BY TREATING THE PIPE WITH PVC GLUE AND SEAL WITH A 3:1 SAND CEMENT MORTAR.
- SW12. ALL CONCRETE PIPES AND ASSOCIATED ELEMENTS SHALL BE MANUFACTURED AND PROVIDED WITH A STRENGTH CLASSIFICATION IN ACCORDANCE WITH AS4058, PRECAST CONCRETE PIPES (PRESSURE AND NON-PRESSURE). SW13. ALL CONCRETE PIPES AND ASSOCIATED ELEMENTS
- LOADS ON BURIED CONCRETE PIERS AND AS3500.3 NATIONAL PLUMBING AND DRAINAGE CODE, PART 3: STORMWATER DRAINAGE. SW14. "K" ON PLAN DENOTES KERB AS DETAILED WITH

SHALL BE INSTALLED IN ACCORDANCE WITH AS3725,

"T.O.K" DENOTING LEVEL FOR TOP OF KERB FOR DATUM INDICATED. SW15. PITS SHALL BE OF A SIZE AS SHOWN OR NOTED WITH GALVANISED GRATED COVERS OR AN APPROVED EQUIVALENT, ALL PITS IN BARKED OR WOODCHIP

> LANDSCAPED AREAS SHALL HAVE COVERS OR STANDARD COVERS MODIFIED TO ENSURE DEBRIS

DOES NOT ENTER STORMWATER SYSTEM.

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1A QUEEN STEET, AUBURN

COVER SHEET PROJECT NO. DESIGN J.T. DRAWN W.S. 5933

DRAWING NO. REV A1 SCALE As indicated DATE MAY 2017 SW.00 B

GENERAL

- G1. THESE DRAWINGS ARE TO BE READ IN CONJUNCTION WITH ALL OTHER RELEVANT DOCUMENTS INCLUDING ALL WORKING DRAWINGS AND SPECIFICATIONS, AND WRITTEN INSTRUCTIONS AS MAY BE ISSUED PRIOR TO OR DURING THE COURSE OF CONSTRUCTION. ALL DISCREPANCIES AND VARIATIONS SHALL BE REFERRED TO THE ENGINEER
- BEFORE PROCEEDING WITH THE WORK.

 G2. ALL STRUCTURAL WORK SHALL BE IN ACCORDANCE WITH THE REQUIREMENTS OF ALL RELEVANT AND
- CURRENT RMS SPECIFICATIONS/CODES.

 G3. STRUCTURAL DRAWINGS SHALL NOT BE SCALED IN ORDER TO OBTAIN DIMENSIONS. DIMENSIONS WHERE SHOWN ON STRUCTURAL DRAWINGS SHALL BE CO-ORDINATED WITH ALL OTHER RELEVANT DRAWINGS.
- G4. DURING CONSTRUCTION, THE STRUCTURE SHALL BE MAINTAINED IN A STABLE CONDITION AND NO PART SHALL BE OVERSTRESSED.

CONSTRUCTION NOTES

GENERAL

- NOT ALL TACKCOATS AND CURING COMPOUNDS ARE SHOWN ON THESE DRAWINGS.
- DRAWINGS TO BE READ IN CONJUNCTION WITH TECHNICAL GUIDE P-G-002.

<u>ASPHALT</u>

- 3. AS PER R116, EACH ASPHALT COURSE DEPTH MUST ALLOW FOR INDIVIDUAL ASPHALT LAYER THICKNESSES. THE RANGE OF ALLOWABLE ASPHALT LAYER THICKNESS DURING PAVING IS LISTED IN TABLE 3.1
- 4. ONLY DENSE GRADED ASPHALT AND STONE MASTIC ASPHALT LAYERS ARE INCLUDED IN THE 175 mm MINIMUM ASPHALT THICKNESS OVER LEAN-MIX CONCRETE OR HEAVILY BOUND MATERIAL. SPRAYED SEALS AND OPEN GRADED ASPHALT WEARING COURSE LAYERS ARE NOT TO BE CONSIDERED AS CONTRIBUTING TO THE 175 mm MINIMUM THICKNESS.

<u>GRANULAR</u>

5. AS PER R71, EACH COURSE THICKNESS IS TO COMPRISE COMPACTED LAYERS THAT ARE NOT MORE THAN 150 mm OR LESS THAN 100 mm THICK (A SPECIFIED COURSE THICKNESS OF 150 - 200 mm DOES NOT COMPLY).

PRIMERSEAL, SPRAYED SEAL AND LOW CUTTER SEAL

- 6. FOR ASPHALT OVER UNBOUND GRANULAR MATERIAL, REFER TO TECHNICAL GUIDE P-G-002.
- 7. USE THE AVERAGE LEAST DIMENSION (ALD) OF SEALING AGGREGATE TO DETERMINE THE CONTRIBUTION OF A SPRAYED SEAL THICKNESS TO THE TOTAL PAVEMENT THICKNESS.
- 8. A LOW CUTTER SEAL IS TO BE PROVIDED AT ALL LOCATIONS WHERE A SPRAYED SEAL IS TO BE PLACE DIRECTLY UNDER AN ASPHALT LAYER.
- 9. THE APPLICATION OF A LOW CUTTER SEAL IS AS FOLLOWS:
 AGGREGATE SPREAD RATE FOR 10 mm AGGREGATE AS PER
 RMS FORM 395K, AGGREGATE DESIGN. AGGREGATE SPREAD
 RATEFOR 7 mm AGGREGATE IS BETWEEN 200 230 m²/m³
 A MAXIMUM OF 2% CUTTER OIL MAY BE USED
 USE 1% ADHESION AGENT

- DOUBLE THE AMOUNT OF ROLLING FOR A SPRAYED SEAL

- TO BE PLACED IN ACCORDANCE WITH R106.

 10. A 7 mm SPRAYED SEAL IS TO BE PROVIDED OVER THE SMZ LAYER.
- EXCEPT AT THE FOLLOWING LOCATIONS:

 (a) DIRECTLY UNDER AN ASPHALT LAYER, WHERE A LOW CUTTER SEAL IS TO BE PROVIDED

 (b) DIRECTLY UNDER A GRANULAR LAYER (AS APPROVED BY THE
- PRINCIPAL)

 11. FINAL SPRAYED SEAL IS TO BE APPLIED 12 MONTHS AFTER APPLICATION OF PRIMERSEAL. PAVEMENT DESIGNER TO NOMINATE FINAL SPRAYED SEAL TYPE.

BITUMINOUS CURING COMPOUND OVER CONCRETE PAVEMENT

12. IF A NON-BITUMINOUS CURING COMPOUND IS USED AS PER R83, IT IS TO BE REMOVED IMMEDIATELY PRIOR TO THE APPLICATION OF A BITUMINOUS QUICK DRYING PRIME, FOLLOWED BY A SPRAYED SEAL OR ASPHALT LAYER.

BITUMINOUS WATERPROOFING MEMBRANE

13. APPLY BITUMINOUS WATERPROOFING MEMBRANE IN ACCORDANCE WITH B344.

DEBONDING TREATMENT

14. APPLY DEBONDING TREATMENT FOR CONCRETE IN ACCORDANCE WITH R82.

BITUMINOUS PRIMER OVER BRIDGE DECK OR APPROACH SLAB

15. APPLY BITUMINOUS PRIMER IN ACCORDANCE WITH B344.

REFERENCES

RMS 3051:GRANULAR BASE AND SUBBASE MATERIALS

FOR SURFACED ROAD PAVEMENTS

RMS B80: CONCRETE WORK FOR BRIDGES
RMS B344:SPRAYED BITUMINOUS WATERPROOFING MEMBRANE

FOR CONCRETE BRIDGE DECKS

RMS R44: EARTHWORKS
RMS R71: CONSTRUCTION OF UNBOUND AND MODIFIED PAVEMENT COURSE
RMS R73: CONSTRUCTION OF PLANT MIXED HEAVILY BOUND PAVEMENT COURSE

RMS R82: LEAN-MIX CONCRETE SUBBASE RMS R83: CONCRETE PAVEMENT BASE

RMS R106:SPRAYED BITUMINOUS SURFACING (WITH CUTBACK BITUMEN)

RMS R116:HEAVY DUTY DENSE GRADED ASPHALT

RMS R119:OPEN GRADED ASPHALT RMS R121:STONE MASTIC ASPHALT

RMS FORM 395K:SEAL OR RESEAL DESIGN CALCULATION SHEET RMS TECHNICAL GUIDE P-G-002 TYPICAL PAVEMENT PROFILES

RMS R141: PAVEMENT MARKING

RMS R53: CONCRETE (FOR GENERAL USE), MORTAR AND GROUT

RMS R15: KERBS AND GUTTERS

RMS Q4: QUALITY MANAGEMENT SYSTEM (TYPE 4)

CONCRETE

- C1. ALL WORKMANSHIP AND MATERIALS SHALL BE IN ACCORDANCE WITH RMS R83,R53 EXCEPT WHERE VARIED BY THE CONTRACT DOCUMENTS.
- CONCRETE COMPOSITION AND CLEAR COVER TO REINFORCEMENT SHALL BE AS FOLLOWS:

ELEMENT	AS 3600 f'c MPa	COVER mm.
FOOTINGS	20	65
ALL - UNO. PAVEMENT	40	40
KERB & GUTTER	32	_

ADMIXTURES, WHERE USED, SHALL COMPLY WITH THE REQUIREMENTS OF RMS R83.

- C3. ALL CONCRETE SUPPLY & TESTING SHALL CONFORM WITH RMS R83.
- C4. CONSTRUCTION JOINTS SHALL BE PROPERLY FORMED AND USED ONLY WHERE SHOWN ON DRAWINGS OR SPECIFICALLY APPROVED BY THE ENGINEER.
- C5. NO HOLES, CHASES OR EMBEDMENTS OF PIPES, OTHER THAN THOSE SHOWN ON THE STRUCTURAL DRAWINGS, SHALL BE MADE IN CONCRETE MEMBERS WITHOUT THE PRIOR APPROVAL OF THE ENGINEER.
- C6. ALL CONCRETE SHALL BE PLACED AND CURED IN ACCORDANCE WITH RMS R83.
- C7. HORIZONTAL FORMWORK SHALL BE STRIPPED WHEN APPROVED BY THE ENGINEER.
- C8. SLABS AND BEAMS SHALL BEAR ONLY ON THE BEAMS, WALLS ETC. SHOWN ON THE STRUCTURAL DRAWINGS. ALL OTHER BUILDING ELEMENTS SHALL BE KEPT 15mm CLEAR OF SOFFITS OF STRUCTURAL ELEMENTS.
- C9. COMPLETED STRUCTURAL ELEMENTS SHALL CONFORM WITH THE SHAPES, LINES, LEVELS, GRADES AND DIMENSIONS REQUIRED BY THE CONTRACT DRAWINGS.
- C10. ALL CONCRETE REINFORCEMENT SHALL CONFORM WITH AS/NZS 4671, DUCTILITY GRADE: CLASS N. NO REINFORCEMENT SHALL BE WELDED WITHOUT PRIOR APPROVAL.
- C11. R = STRUCTURAL GRADE ROUND BAR
 N = "TEMPCORE" DEFORMED BAR
 F = HARD DRAWN STEEL WIRE REINFORCING FABRIC
 DESIGNATION CODE OF REINFORCEMENT BARS:-

NO. OF BARS — BAR GRADE AND TYPE

14 N16-300

NOMINAL BAR SIZE SPACING IN mm

UNO - UNLESS NOTED OTHERWISE. NSOP - NOT SHOWN ON PLAN.

- LV LENGTH VARIES.
 C12. TRANSVERSE TIE BARS N12-300, WHERE NOT
 OTHERWISE SHOWN. SPLICE WHERE NECESSARY
 AND LAP WITH MAIN BARS 400mm.
- C13. SPLICES IN REINFORCEMENT SHALL BE MADE ONLY IN POSITIONS SHOWN ON THE STRUCTURAL DRAWINGS OR IN POSITIONS OTHERWISE APPROVED IN WRITING BY THE PRINCIPAL. LAPS SHALL BE IN ACCORDANCE WITH AS3600 AND NOT LESS THAN THE DEVELOPMENT FOR EACH BAR. SITE BENDING OF REINFORCING BARS SHALL BE DONE WITHOUT HEATING USING MECHANICAL BENDING TOOLS. WELDING OF REINFORCEMENT SHALL NOT BE PERMITTED UNLESS SHOWN ON THE STRUCTURAL DRAWINGS OR APPROVED BY THE STRUCTURAL ENGINEER. FABRICS SHALL BE LAPPED 2 RANSVERSE WIRES PLUS 50mm. BUNDLED BARS SHALL BE TIED TOGETHER AT 30 BAR DIAMETER CENTRES WITH THREE WRAPS OF TIE WIRE.
- C14. REINFORCEMENT IS SHOWN DIAGRAMMATICALLY. IT IS NOT NECESSARILY SHOWN IN TRUE
- PROJECTION.
 C15. ALL REINFORCEMENT SHALL BE MAINTAINED IN POSITION DURING CONCRETING.

QUALITY ASSURANCE

- 1. THE CONTRACTOR SHALL IMPLEMENT AND MAINTAIN A QUALITY ASSURANCE SYSTEM MEETING THE REQUIREMENTS OF RMS Q4 BE SUCH THAT RECORDS ARE KEPT OF ALL ASPECTS AND STAGES OF THE WORK.
- 2. THE RECORDS FOR EACH CONSTRUCTION TASK SHALL BE STAGED AND ITEMISED TO THE SATISFACTION OF THE CONTRACTOR ADMINISTRATOR. THE PROFORMAS FOR RECORDS SHALL BE SUBMITTED TO THE CONTRACTOR ADMINISTRATOR FOR APPROVAL AND WORK SHALL NOT COMMENCE UNTIL SUCH APPROVAL
- HAS BEEN GIVEN.

 DURING THE COURSE OF CONSTRUCTION, THE CONTRACTOR SHALL MAINTAIN ACCURATE AND UP TO DATE RECORDS AND SHALL MAKE SUCH RECORDS AVAILABLE TO THE CONTRACTOR ADMINISTRATOR IF REQUESTED. FAILURE TO MAINTAIN RECORDS AS SPECIFIED WILL RESULT IN THE CONTRACTOR RE-INSPECTING COMPLETED WORKS IF INSTRUCTED TO
- DO SO BY THE CONTRACTOR ADMINISTRATOR.

 4. AT THE COMPLETION OF EACH STAGE OF THE WORKS THE CONTRACTOR SHALL CERTIFY THAT THOSE WORKS HAVE BEEN UNDERTAKEN AND COMPLETED IN ACCORDANCE WITH THE DRAWINGS, SPECIFICATION AND INSTRUCTIONS ISSUED DURING THE COURSE OF THE CONTRACT.

ASPHALTIC CONCRETE NOTES

GENERAL

- MINERAL AGGREGATES TO COMPLY WITH CLAUSE
 2.1 MATERIALS OF RMS SPECIFICATION R116
 "ASPHALT (DENSE AND OPEN GRADED)".
- 2. MINERAL FILLER TO COMPLY WITH AS 2357 (LATEST EDITION) MINERAL FILLERS FOR ASPHALT AND CLAUSE 2.1.2 FILLER OF RMS SPECIFICATION R116 "ASPHALT (DENSE AND OPEN GRADED)".
- 3. BITUMEN BINDER SHALL COMPLY WITH CLAUSE 2.1.3 -BINDER OF RMS SPECIFICATION R116 - "ASPHALT (DENSE AND OPEN GRADED)".

MIX PROPORTIONS

- JOB MIX 10mm AND 20mm (AS SPECIFIED ON DRAWINGS) NOMINAL SIZE AGGREGATE MINIMUM BITUMEN CONTENT (%) BY MASS OF TOTAL MASS -
- 9. 1%.
 AIR VOIDS IN COMPACTED MIX BETWEEN 4% AND
 7% OF THE VOLUME OF THE MIX.
- 3. VOIDS FILLED IN BINDER 65-80% OF AIR VOIDS IN THE TOTAL MINERAL AGGREGATE FILLED BY BINDER IN ACCORDANCE WITH RMS TEST METHOD T605 AND T607.

PAVEMENT PREPARATION_

- THE EXISTING SURFACE TO BE SEALED SHALL BE DRY AND BROOMED BEFORE COMMENCEMENT OF WORK TO ENSURE COMPLETE REMOVAL OF ALL SUPERFICIAL FOREIGN MATTER.
- 2. ALL DEPRESSIONS OR UNEVEN AREAS ARE TO BE TACK-COATED AND BROUGHT UP TO GENERAL LEVEL OF PAVEMENT WITH ASPHALTIC CONCRETE BEFORE LAYING OF MAIN COURSE.

TACK COAT

THE WHOLE OF THE AREA TO BE SHEETED WITH ASPHALTIC CONCRETE SHALL BE LIGHTLY AND EVENLY COATED WITH RAPID SETTING BITUMEN COMPLYING WITH RMS SPECIFICATIONS 3252, 3253, 3254, 3259 AND 3269. APPLICATION RATE FOR RESIDUAL BITUMEN SHALL BE 0.15 TO 0.30 LITRES/SQUARE METRE. APPLICATION SHALL BE BY MEANS OF A MECHANICAL SPRAYER WITH SPRAY BAR.

SPREADING

- 1. ALL ASPHALTIC CONCRETE SHALL BE SPREAD WITH A SELF PROPELLED PAVING MACHINE.
- 2. THE ASPHALTIC CONCRETE SHALL BE LAID AT A MIX TEMPERATURE AS SHOWN BELOW: ROAD SURFACE TEMPERATURE IN SHADE A(°C), MIX TEMPERATURES (°C) 5-10°C: NOT PERMITTED
 - 10-15°C: 150°C 15-25°C: 145°C OVER 25°C: 140°C
- B. ASPHALTIC CONCRETE SHALL NOT BE LAID WHEN THE ROAD SURFACE IS WET OR WHEN COLD WINDS CHILL THE MIX TO ADVERSELY AFFECT SPREADING AND COMPACTION.

JOINTS

- 1. THE NUMBER OF JOINTS BOTH LONGITUDINAL AND TRANSVERSE SHALL BE KEPT TO A MINIMUM.
- THANSVERSE SHALL BE KEPT TO A MINIMUM.

 THE DENSITY AND SURFACE FINISH AT JOINTS SHALL BE SIMILAR TO THOSE OF THE REMAINDER OF THE LAYER.

COMPACTION

- 1. ALL COMPACTION SHALL BE UNDERTAKEN USING SELF
- PROPELLED ROLLERS.

 2. INITIAL ROLLING SHALL BE COMPLETED BEFORE THE MIX TEMPERATURE FALLS BELOW 105°C.
- 3. SECONDARY ROLLING SHALL BE COMPLETED BEFORE THE MIX TEMPERATURE FALLS BELOW 60°C USE PNEUMATIC TYRED ROLLER.
- MINIMUM CHARACTERISTICS VALUE OF RELATIVE COMPACTION OF A LOT WHEN TESTED IN ACCORDANCE WITH CLAUSE 4.9 COMPACTION OF RMS SPECIFICATION 116 "ASPHALT (DENSE AND OPEN GRADED)" SHALL BE 95%.

FINISHED PAVEMENT PROPERTIES

FINISHED SURFACES SHALL BE SMOOTH DENSE AND TRUE TO SHAPE AND SHALL NOT VARY MORE THAN 10MM FROM THE SPECIFIED PLAN LEVEL AT ANY POINT AND SHALL NOT DEVIATE FROM THE BOTTOM OF A 3M STRAIGHT EDGE LAID IN ANY DIRECTION BY MORE THAN 5MM.

EARTHWORKS

- 1. THE CONTRACTOR SHALL PROVIDE PROPER FENCING, GUARDING, LIGHTING AND OBSERVATION OF ALL EARTHWORKS, TEMPORARY ROADWAYS, FOOTWAYS, GUARDS AND FENCES AS MAY BE RENDERED NECESSARY FOR THE ACCOMMODATION AND PROTECTION OF PEDESTRIANS, VEHICLES, ANIMALS AND THE PUBLIC.
- DURING THE EXECUTION OF WORKS, THE CONTRACTOR SHALL MAINTAIN THE INTEGRITY OF EXISTING SERVICES THE CONTRACTOR SHALL REPAIR ANY DAMAGE CAUSED TO THE EXISTING SERVICES TO THE SATISFACTION OF THE SUPERINTENDENT AND THE RELEVANT SERVICE AUTHORITY, AT NO COST TO THE PRINCIPAL.
- WHERE IT IS NECESSARY TO REMOVE, DIVERT OR CUT INTO ANY EXISTING SERVICE, THE CONTRACTOR SHALL GIVE AT LEAST THREE (3) DAYS NOTICE OF ITS REQUIREMENTS TO THE SUPERINTENDENT, WHO WILL ADVISE WHAT ARRANGEMENTS SHOULD BE MADE FOR THE ALTERATION OF SUCH EXISTING WORKS
- 4. THE EXCAVATION SHALL BE CARRIED OUT IN THE LOCATIONS SHOWN AND TO THE LEVELS, WIDTHS AND BATTER SLOPES INDICATED ON THE DRAWINGS.
- 5. EXCAVATED MATERIAL NOT MEETING THE SPECIFICATION FOR FILL MATERIAL SHALL BE DISPOSED OF OFF SITE IN AN APPROPRIATE MANNER.
- WHERE EXCAVATION WORK IS REQUIRED IN THE VICINITY
 OF EXISTING SERVICES, THE CONTRACTOR SHALL
 SUPPORT ALL SERVICES DURING THE WORKS.
 WHERE EXCAVATED MATERIAL IS TO BE USED FOR

FILLING, THE MATERIAL SHALL BE INSPECTED AND

- 8. UNLESS SPECIFIED OTHERWISE ALL FILL SHALL BE COMPACTED TO A STANDARD MAXIMUM DRY DENSITY RATIO BETWEEN 98% 102% MAXIMUM AT -1% TO +3% OF STANDARD OPTIMUM MOISTURE CONTENT AS
- DETERMINED BY AS1289.5.4.1 (LATEST ADDITION)

 9. ALL WASTE MATERIALS SHALL BE DISPOSED OFF-SITE IN AN APPROPRIATE MANNER.
- WHERE ROCK IS EXPOSED DURING EXCAVATION, THE CONTRACTOR SHALL CEASE EXCAVATION AT THIS LOCALITY AND CONTACT THE SUPERINTENDENT WHO WILL THEN ADVISE ON THE LEVEL TO WHICH EXCAVATION IS TAKEN.
- 11. THE CONTRACTOR SHALL AT ITS OWN EXPENSE DO ALL THINGS NECESSARY TO DIVERT ANY WATER INTERFERING WITH THE PROGRESS OF WORKS, KEEP THE EXCAVATIONS AND TRENCHES FREE FROM WATER WHILE THE WORKS ARE IN PROGRESS AND PREVENT ANY DAMAGE TO THE WORKS BY WATER DUE TO FLOODS OR OTHER CAUSES. THE CONTRACTOR SHALL HAVE PUMPING EQUIPMENT FOR KEEPING THE EXCAVATION OR TRENCHES CONSTANTLY DEWATERED DURING THE TIMES THE WORKS ARE IN PROGRESS. ANY WORK OR MATERIAL DAMAGED BY WATER SHALL BE MADE GOOD BY THE CONTRACTOR.
- MADE GOOD BY THE CONTRACTOR.

 WHERE DIRECTED BY THE SUPERINTENDENT THE
 BOTTOM OF TRENCHES OR EXCAVATIONS SHALL BE
 COMPACTED PRIOR TO THE PLACING OF ANY BEDDING
 OR CONCRETE MATERIALS.SHOULD, IN THE OPINION OF
 THE SUPERINTENDENT, THE FOUNDATION MATERIAL BE
 INCAPABLE OF EFFECTIVE COMPACTION, THE MATERIAL
 SHALL BE REMOVED AND REPLACED WITH
 APPROPRIATE MATERIAL.

GENERAL COMPACTION NOTES

- FOUNDATION MATERIAL DEEMED BY THE SUPERINTENDENT
 AS UNSUITABLE TO BE REMOVED AS DIRECTED BY THE
 SUPERINTENDENT AND REPLACED WITH APPROVED
- MATERIAL SATISFYING THE REQUIREMENTS LISTED BELOW.

 2. UNLESS OTHERWISE APPROVED OR SPECIFIED. ALL FILL MATERIAL SHALL BE FROM A SOURCE APPROVED BY THE SUPERINTENDENT AND SHALL COMPLY WITH THE FOLLOWING: A) FREE FROM ORGANIC AND PERISHABLE MATTER B) MAXIMUM PARTICLE SIZE 75MM C) PLASTICITY INDEX BETWEEN 2% AND 20%
- D) CBR > 10
 3. SELECT FILL MATERIAL SHALL BE PLACED IN MAXIMUM 200MM LOOSE THICK LAYERS AND COMPACTED AT OPTIMUM MOISTURE CONTENT (+ OR 2%) TO ACHIEVE A DRY DENSITY DETERMINED IN ACCORDANCE WITH AS1289E3.1 OF NOT LESS THAN THE FOLLOWING STANDARD MAXIMUM DRY DENSITY IN ACCORDANCE WITH AS1289E1.1:
- 4. LOCATION STANDARD DRY DENSITY
 -AREAS OF SERVICE TRENCHES 98%
 -EMBANKMENTS 100%
 -LANDSCAPED AREAS 90%
- -CONCRETE FOUNDATIONS 100%

 THE CONTRACTOR SHALL PROGRAMME THE EARTHWORKS OPERATION SO THAT THE WORKING AREAS ARE ADEQUATELY DRAINED DURING THE PERIOD OF CONSTRUCTION. THE SURFACE SHALL BE GRADED AND SEALED OFF TO REMOVE DEPRESSIONS. ROLLER MARKS AND SIMILAR WHICH WOULD ALLOW WATER TO POND AND PENETRATE THE UNDERLYING MATERIAL. ANY DAMAGE RESULTING FROM THE CONTRACTOR NOT OBSERVING THESE REQUIREMENTS SHALL BE RECTIFIED BY THE CONTRACTOR AT HIS COST.
- 6. COMPACTION CONTROL TESTING SHALL BE CARRIED OUT BY AND AT THE COST OF THE CONTRACTOR TO CONFORM WITH LEVEL 1. AS DEFINED IN AS3798 (LATEST EDITION).

FILL

- 1. FOUNDATION MATERIAL DEEMED BY THE SUPERINTENDENT AS UNSUITABLE TO BE REMOVED AS DIRECTED BY THE SUPERINTENDENT AND REPLACED WITH APPROVED MATERIAL SATISFYING
- THE REQUIREMENTS LISTED BELOW.

 2. UNLESS OTHERWISE APPROVED OR SPECIFIED. ALL FILL MATERIAL SHALL BE FROM A SOURCE APPROVED BY THE SUPERINTENDENT AND SHALL COMPLY WITH THE FOLLOWING:

 A) FREE FROM ORGANIC AND PERISHABLE MATTER B) MAXIMUM PARTICLE SIZE 75MM
 C) PLASTICITY INDEX BETWEEN 2% AND 20%
- D) CBR > 10
 SELECT FILL MATERIAL SHALL BE PLACED IN
 MAXIMUM 200MM LOOSE THICK LAYERS AND
 COMPACTED AT OPTIMUM MOISTURE CONTENT (+ OR
 2%) TO ACHIEVE A DRY DENSITY DETERMINED IN
 ACCORDANCE WITH AS1289E3.1 (LATEST EDITION)
 OF NOT LESS THAN THE FOLLOWING STANDARD
 MAXIMUM DRY DENSITY IN ACCORDANCE WITH
 AS1289E1.1 (LATEST EDITION):
 LOCATION STANDARD DRY DENSITY
 -AREAS OF SERVICE TRENCHES 98%
 -ROAD AND CARPARKS 100%
- 4. THE CONTRACTOR SHALL PROGRAMME THE EARTHWORKS OPERATION SO THAT THE WORKING AREAS ARE ADEQUATELY DRAINED DURING THE PERIOD OF CONSTRUCTION. THE SURFACE SHALL BE GRADED AND SEALED OFF TO REMOVE DEPRESSIONS. ROLLER MARKS AND SIMILAR WHICH WOULD ALLOW WATER TO POND AND PENETRATE THE UNDERLYING MATERIAL. ANY DAMAGE RESULTING FROM THE CONTRACTOR NOT OBSERVING THESE REQUIREMENTS SHALL BE RECTIFIED BY THE CONTRACTOR AT HIS COST.

-LANDSCAPED AREAS 90%

- 5. COMPACTION CONTROL TESTING SHALL BE CARRIED OUT BY AND AT THE COST OF THE CONTRACTOR TO CONFORM WITH LEVEL 1, AS DEFINED IN AS3798 (LATEST EDITION).
- 6. REPLACEMENT SUBGRADE MATERIAL MAY
 COMPRISE GRANULAR FILL MATERIAL AND SHOULD
 HAVE A CBR OF AT LEAST 10%. REPLACEMENT
 SUBGRADE FILL SHALL BE PLACED ON PROOF
 ROLLED SUBGRADE IN HORIZONTAL LAYERS OF
 200MM TO 250MM MAXIMUM LOOSE THICKNESS
 (DEPENDING ON THE SIZE OF THE EQUIPMENT) AND
 COMPACTED TO A MINIMUM DRY DENSITY RATIO
 (MDDR) OF 98% STANDARD, AT MOISTURE CONTENT
 WITHIN 2% OF OPTIMUM MOISTURE CONTENT.
- 7. WHERE EXCAVATED MATERIAL IS TO BE USED FOR FILLING, THE MATERIAL SHALL BE INSPECTED AND APPROVED BY THE SUPERINTENDENT PRIOR TO

SIGNAGE & LINEMARKING

1. ALL SIGNAGE & LINEMARKING TO BE IN ACCORDANCE WITH RELEVANT AUSTRALIAN STANDARD & RMS SPECIFICATION.

LANDSCAPING (PUBLIC ROAD RESERVE)

- ALL LANDSCAPING TO BE UNDERTAKEN IN
 ACCORDANCE WITH THE REQUIREMENTS OF ASHFIELD
- COUNCIL.

 2. FOR DETAILS OF ALL LANDSCAPING REFER TO DRAWINGS BY HASSELL.

WS RY ISSUE FOR DA 09.03.2018 A
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PROJECT
1A QUEEN STEET, AUBURN

	GENERIAL NOTES					
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(CHKD.			593	33	
A	APPRD.			DRAWING NO.	REV	


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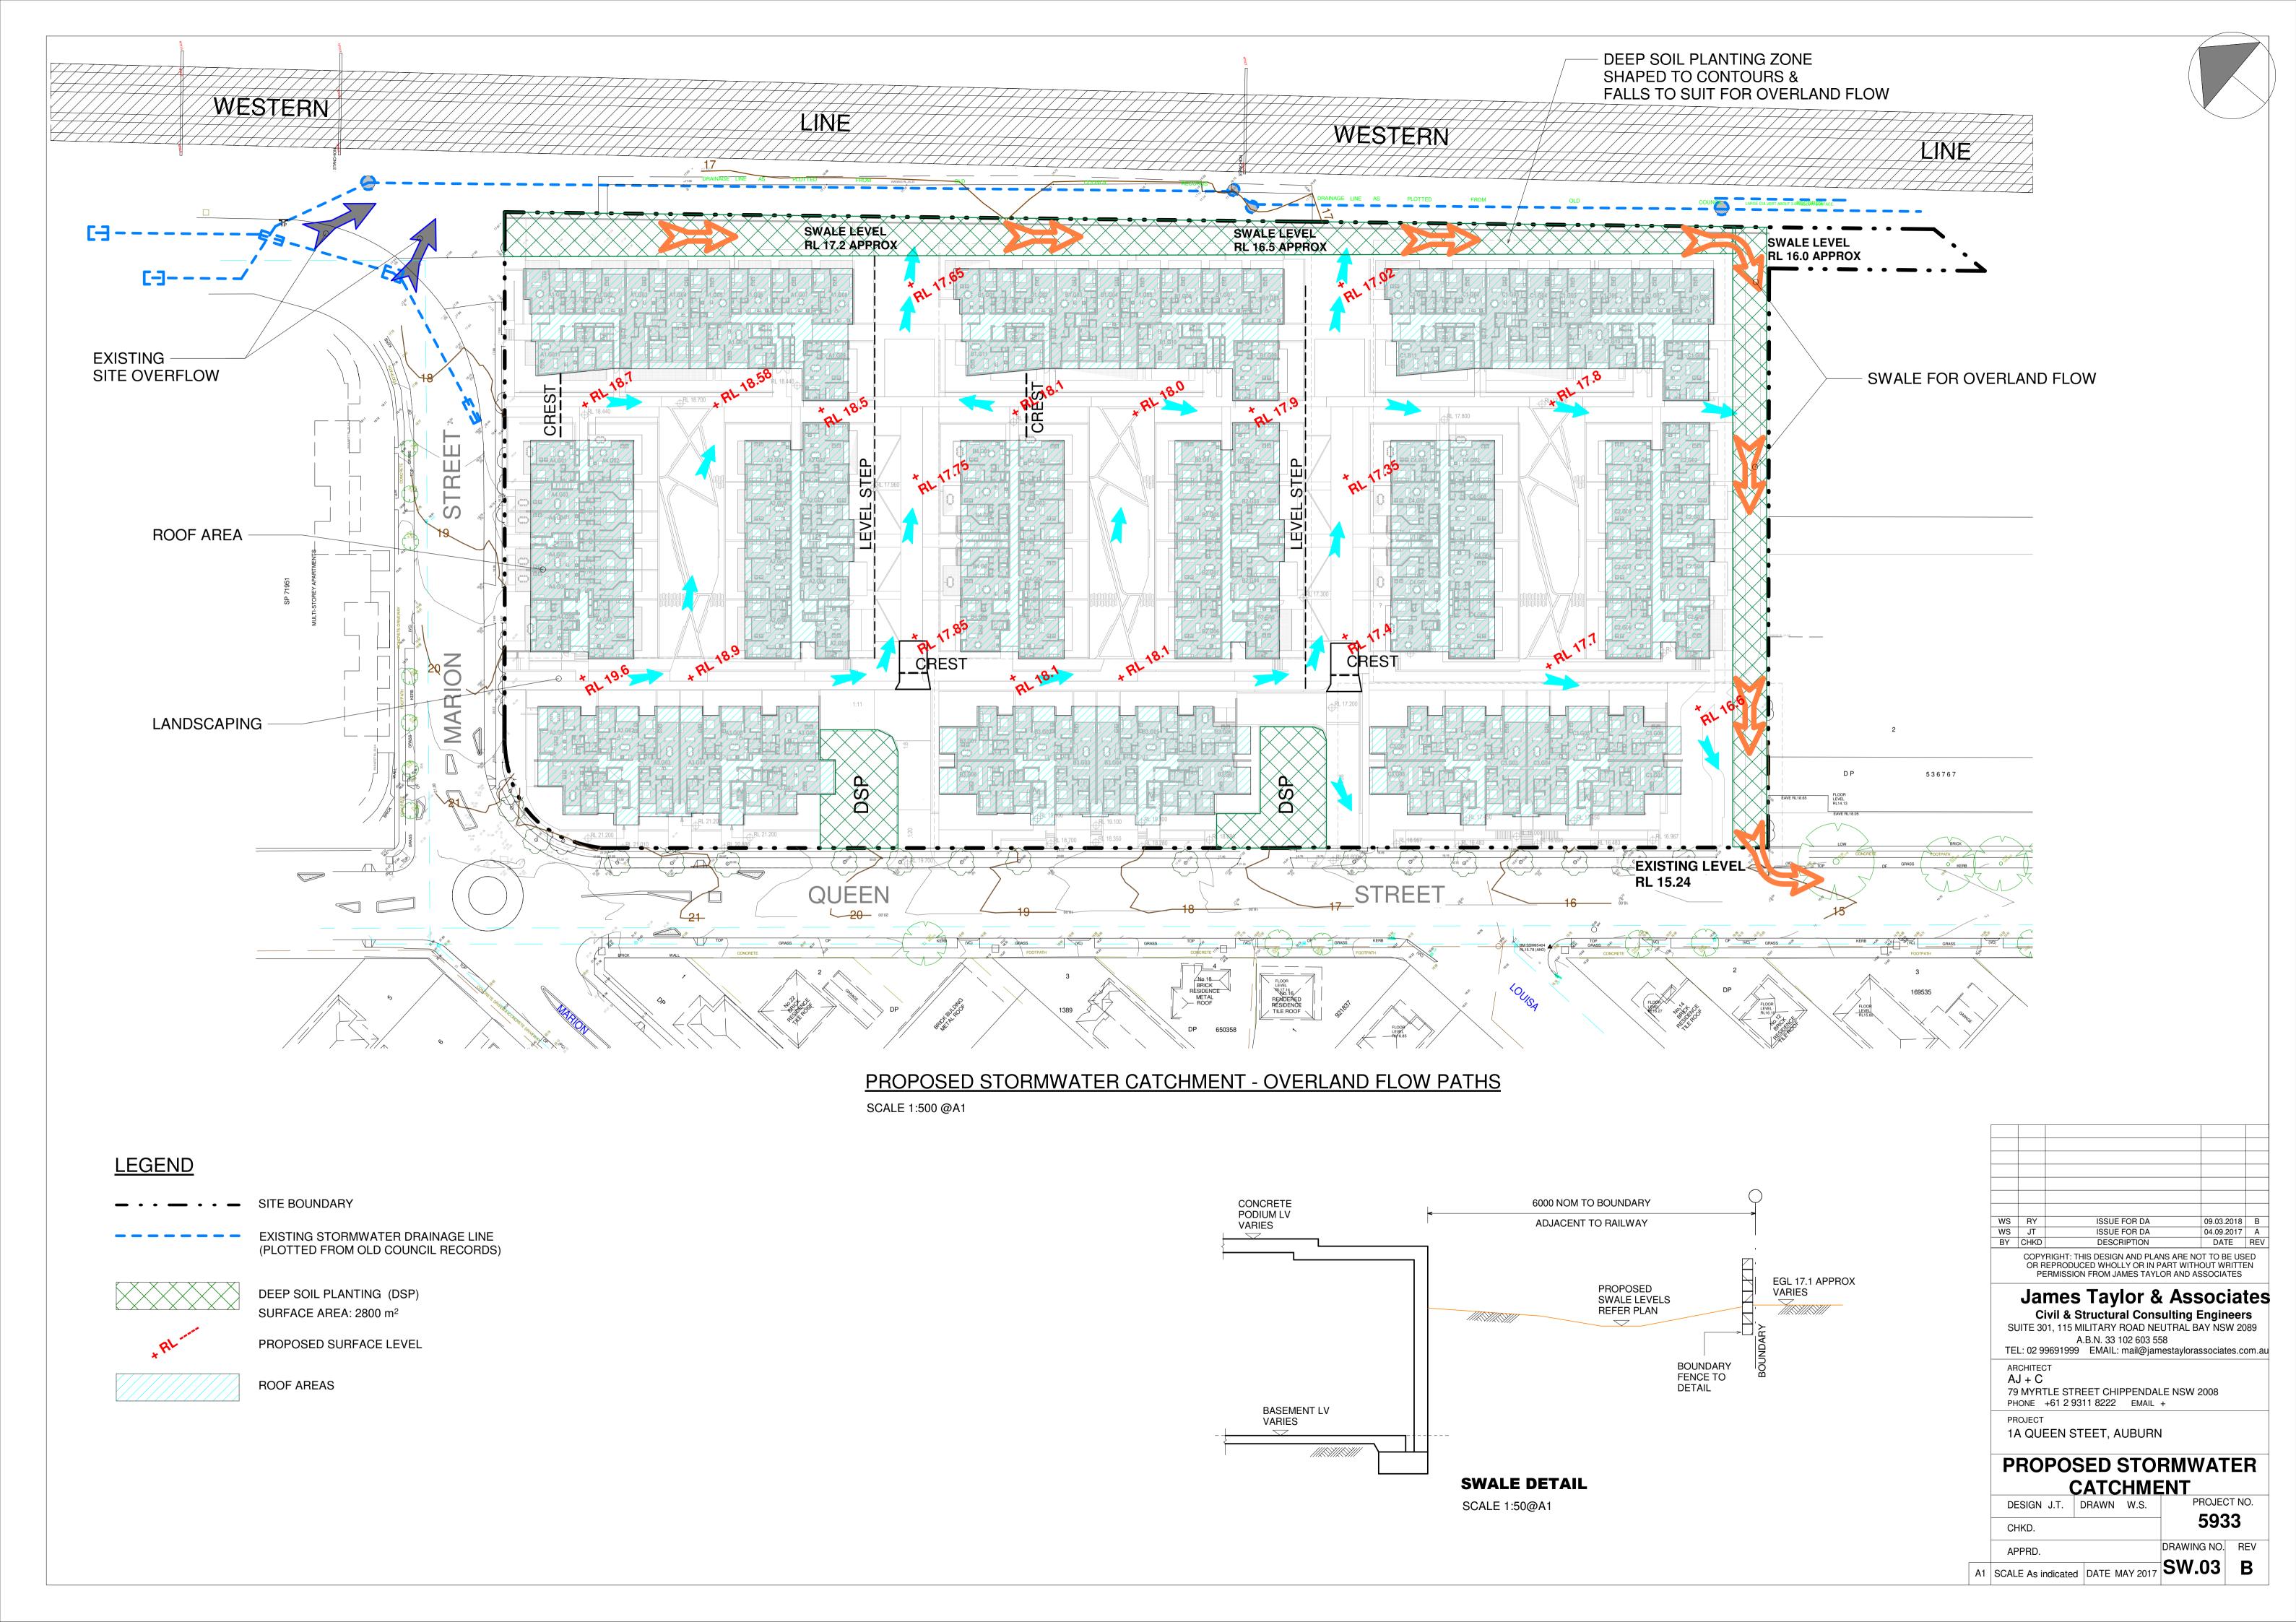
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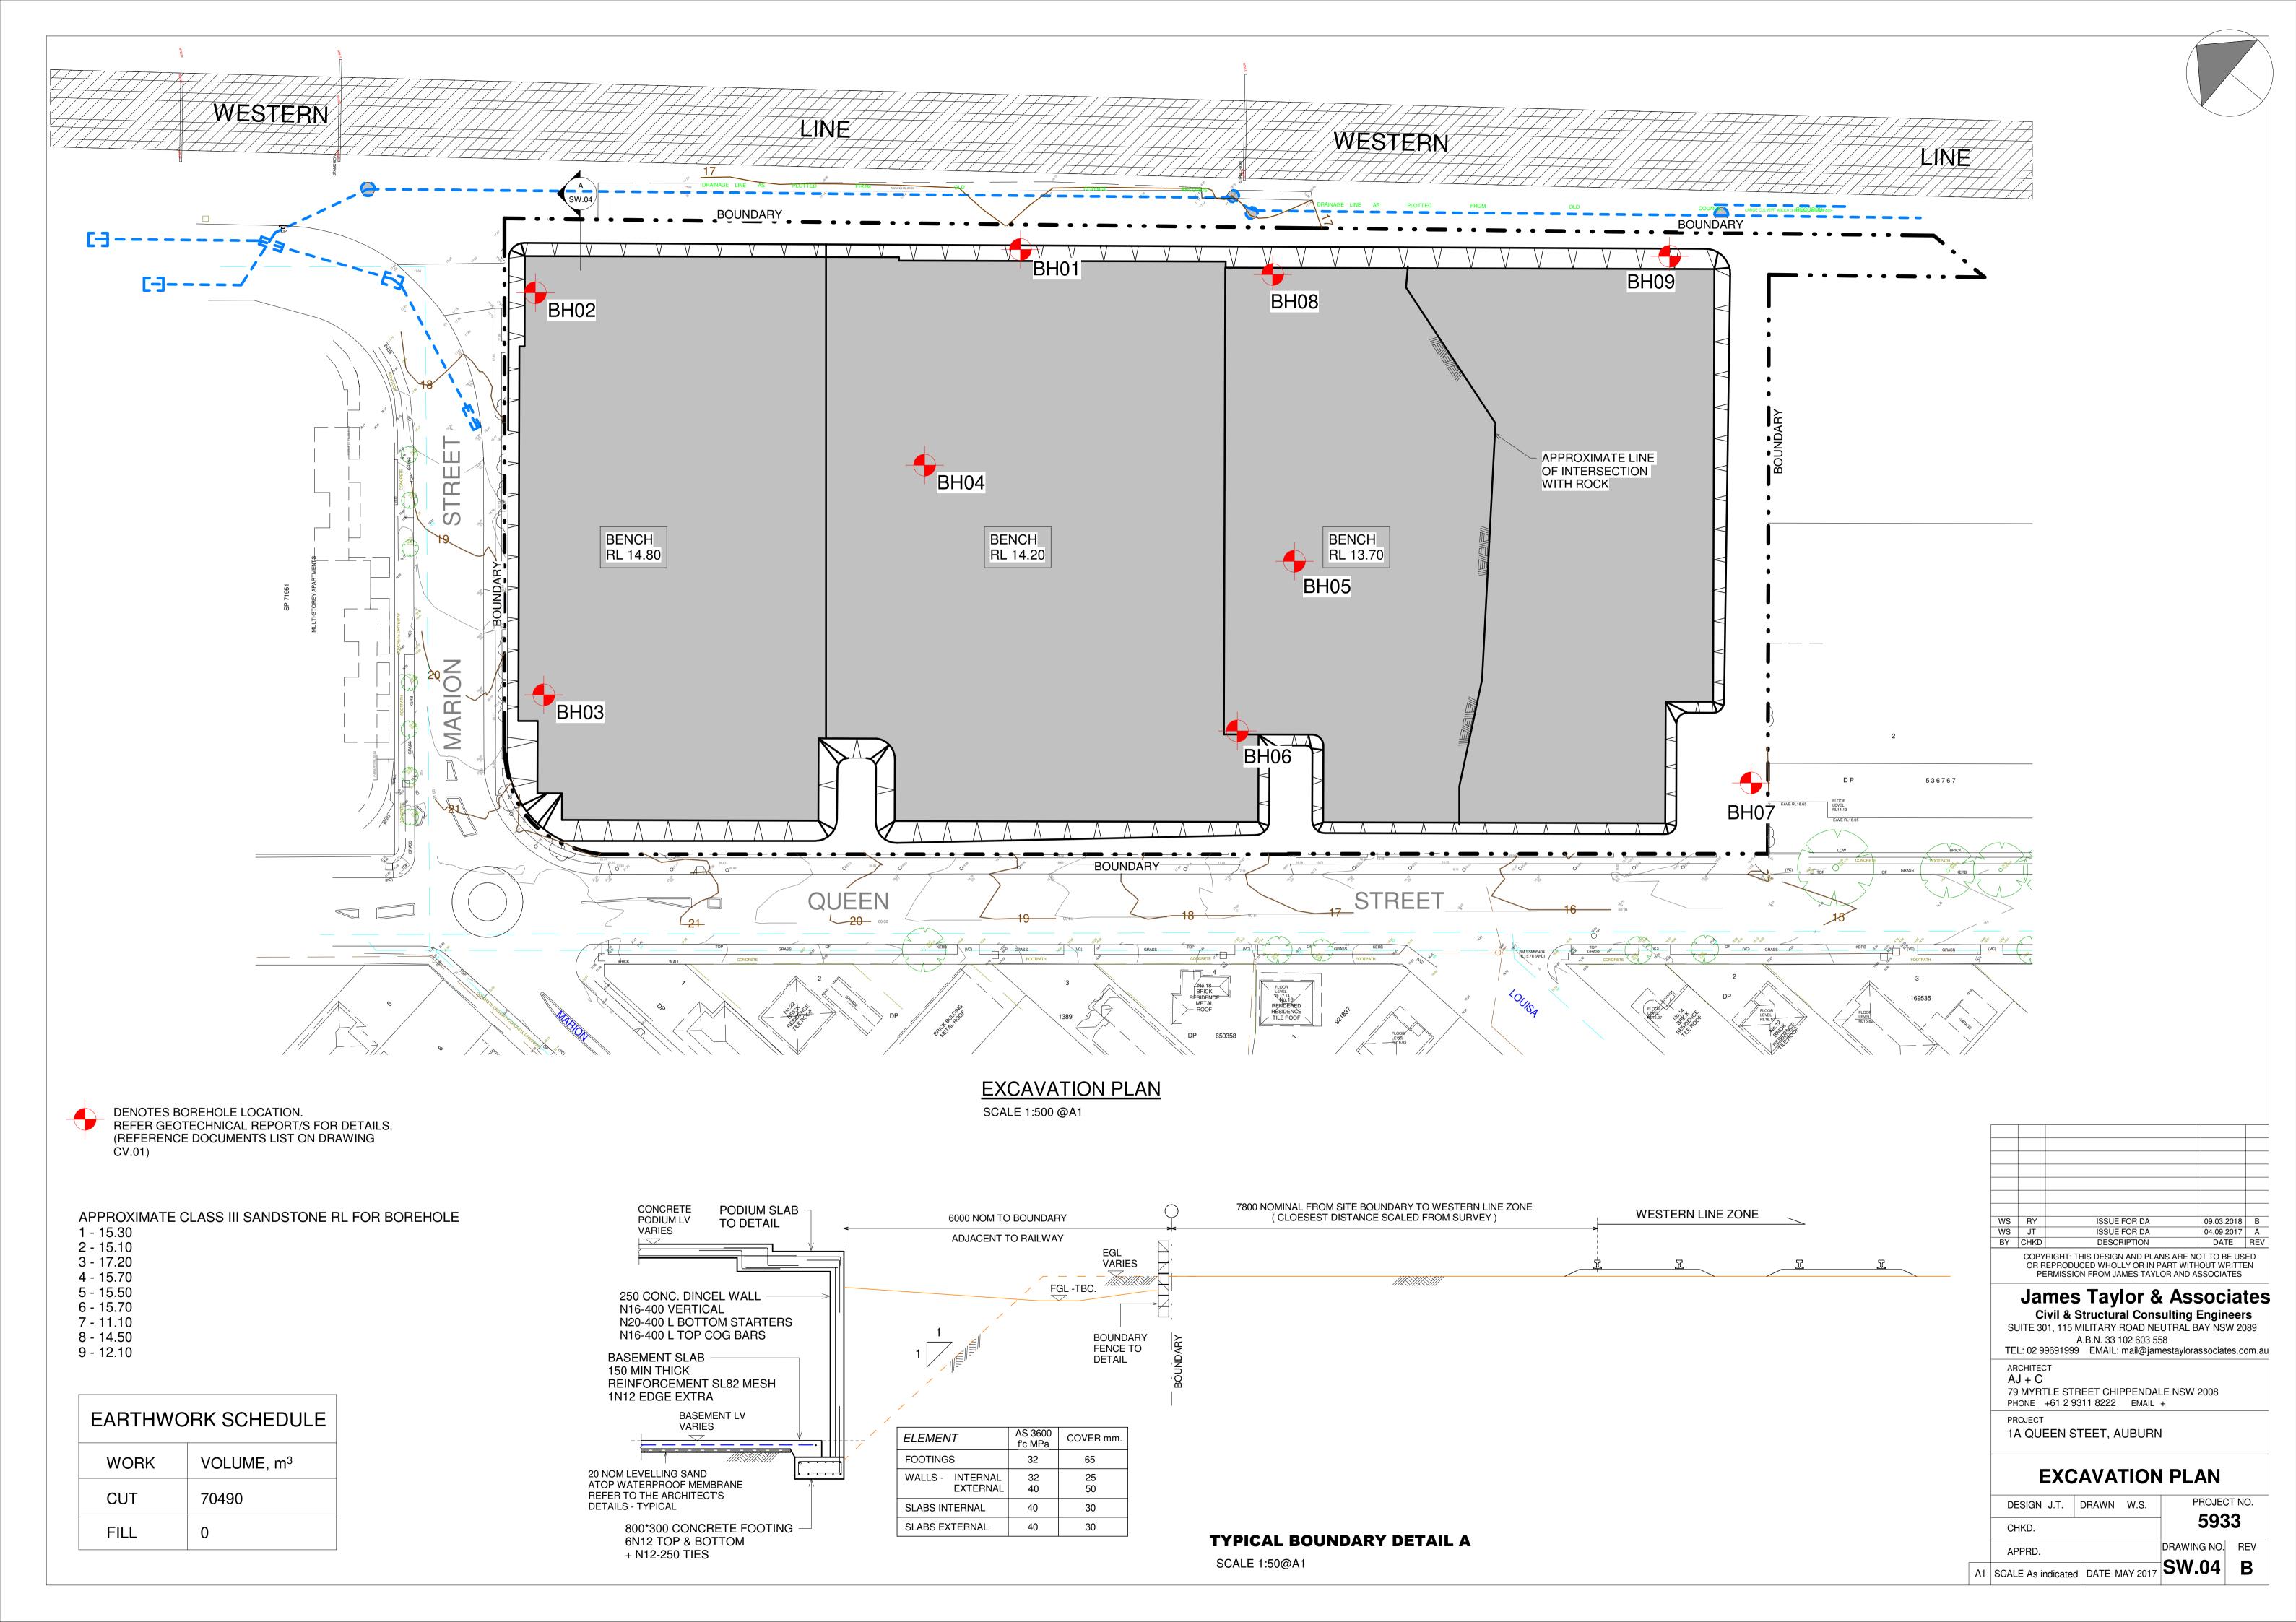
A1 SCALE 1:1 DATE MAY 2017


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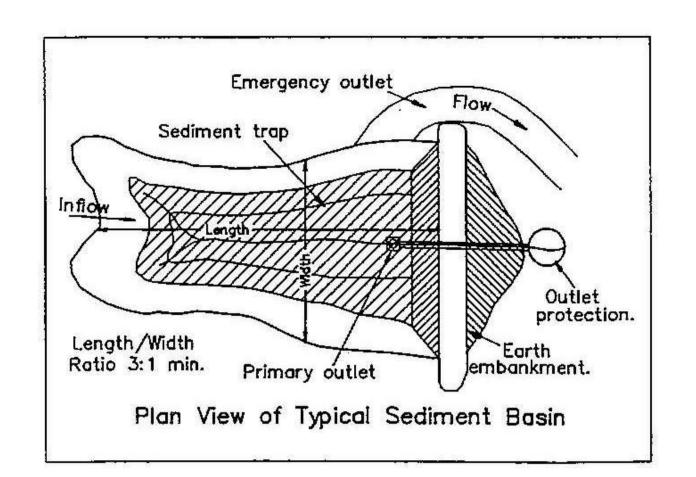
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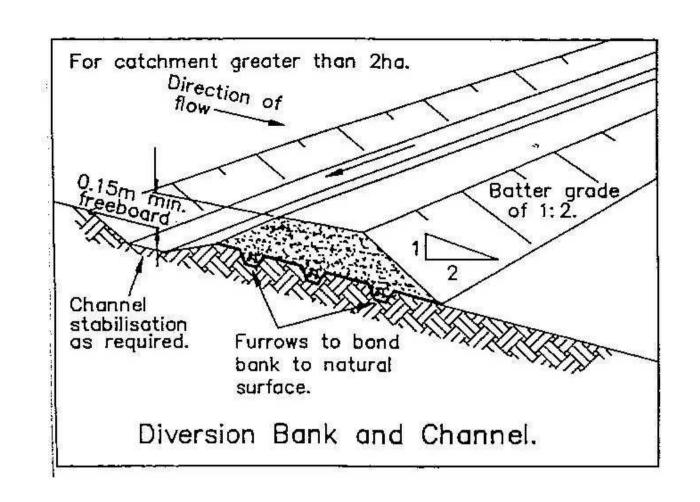











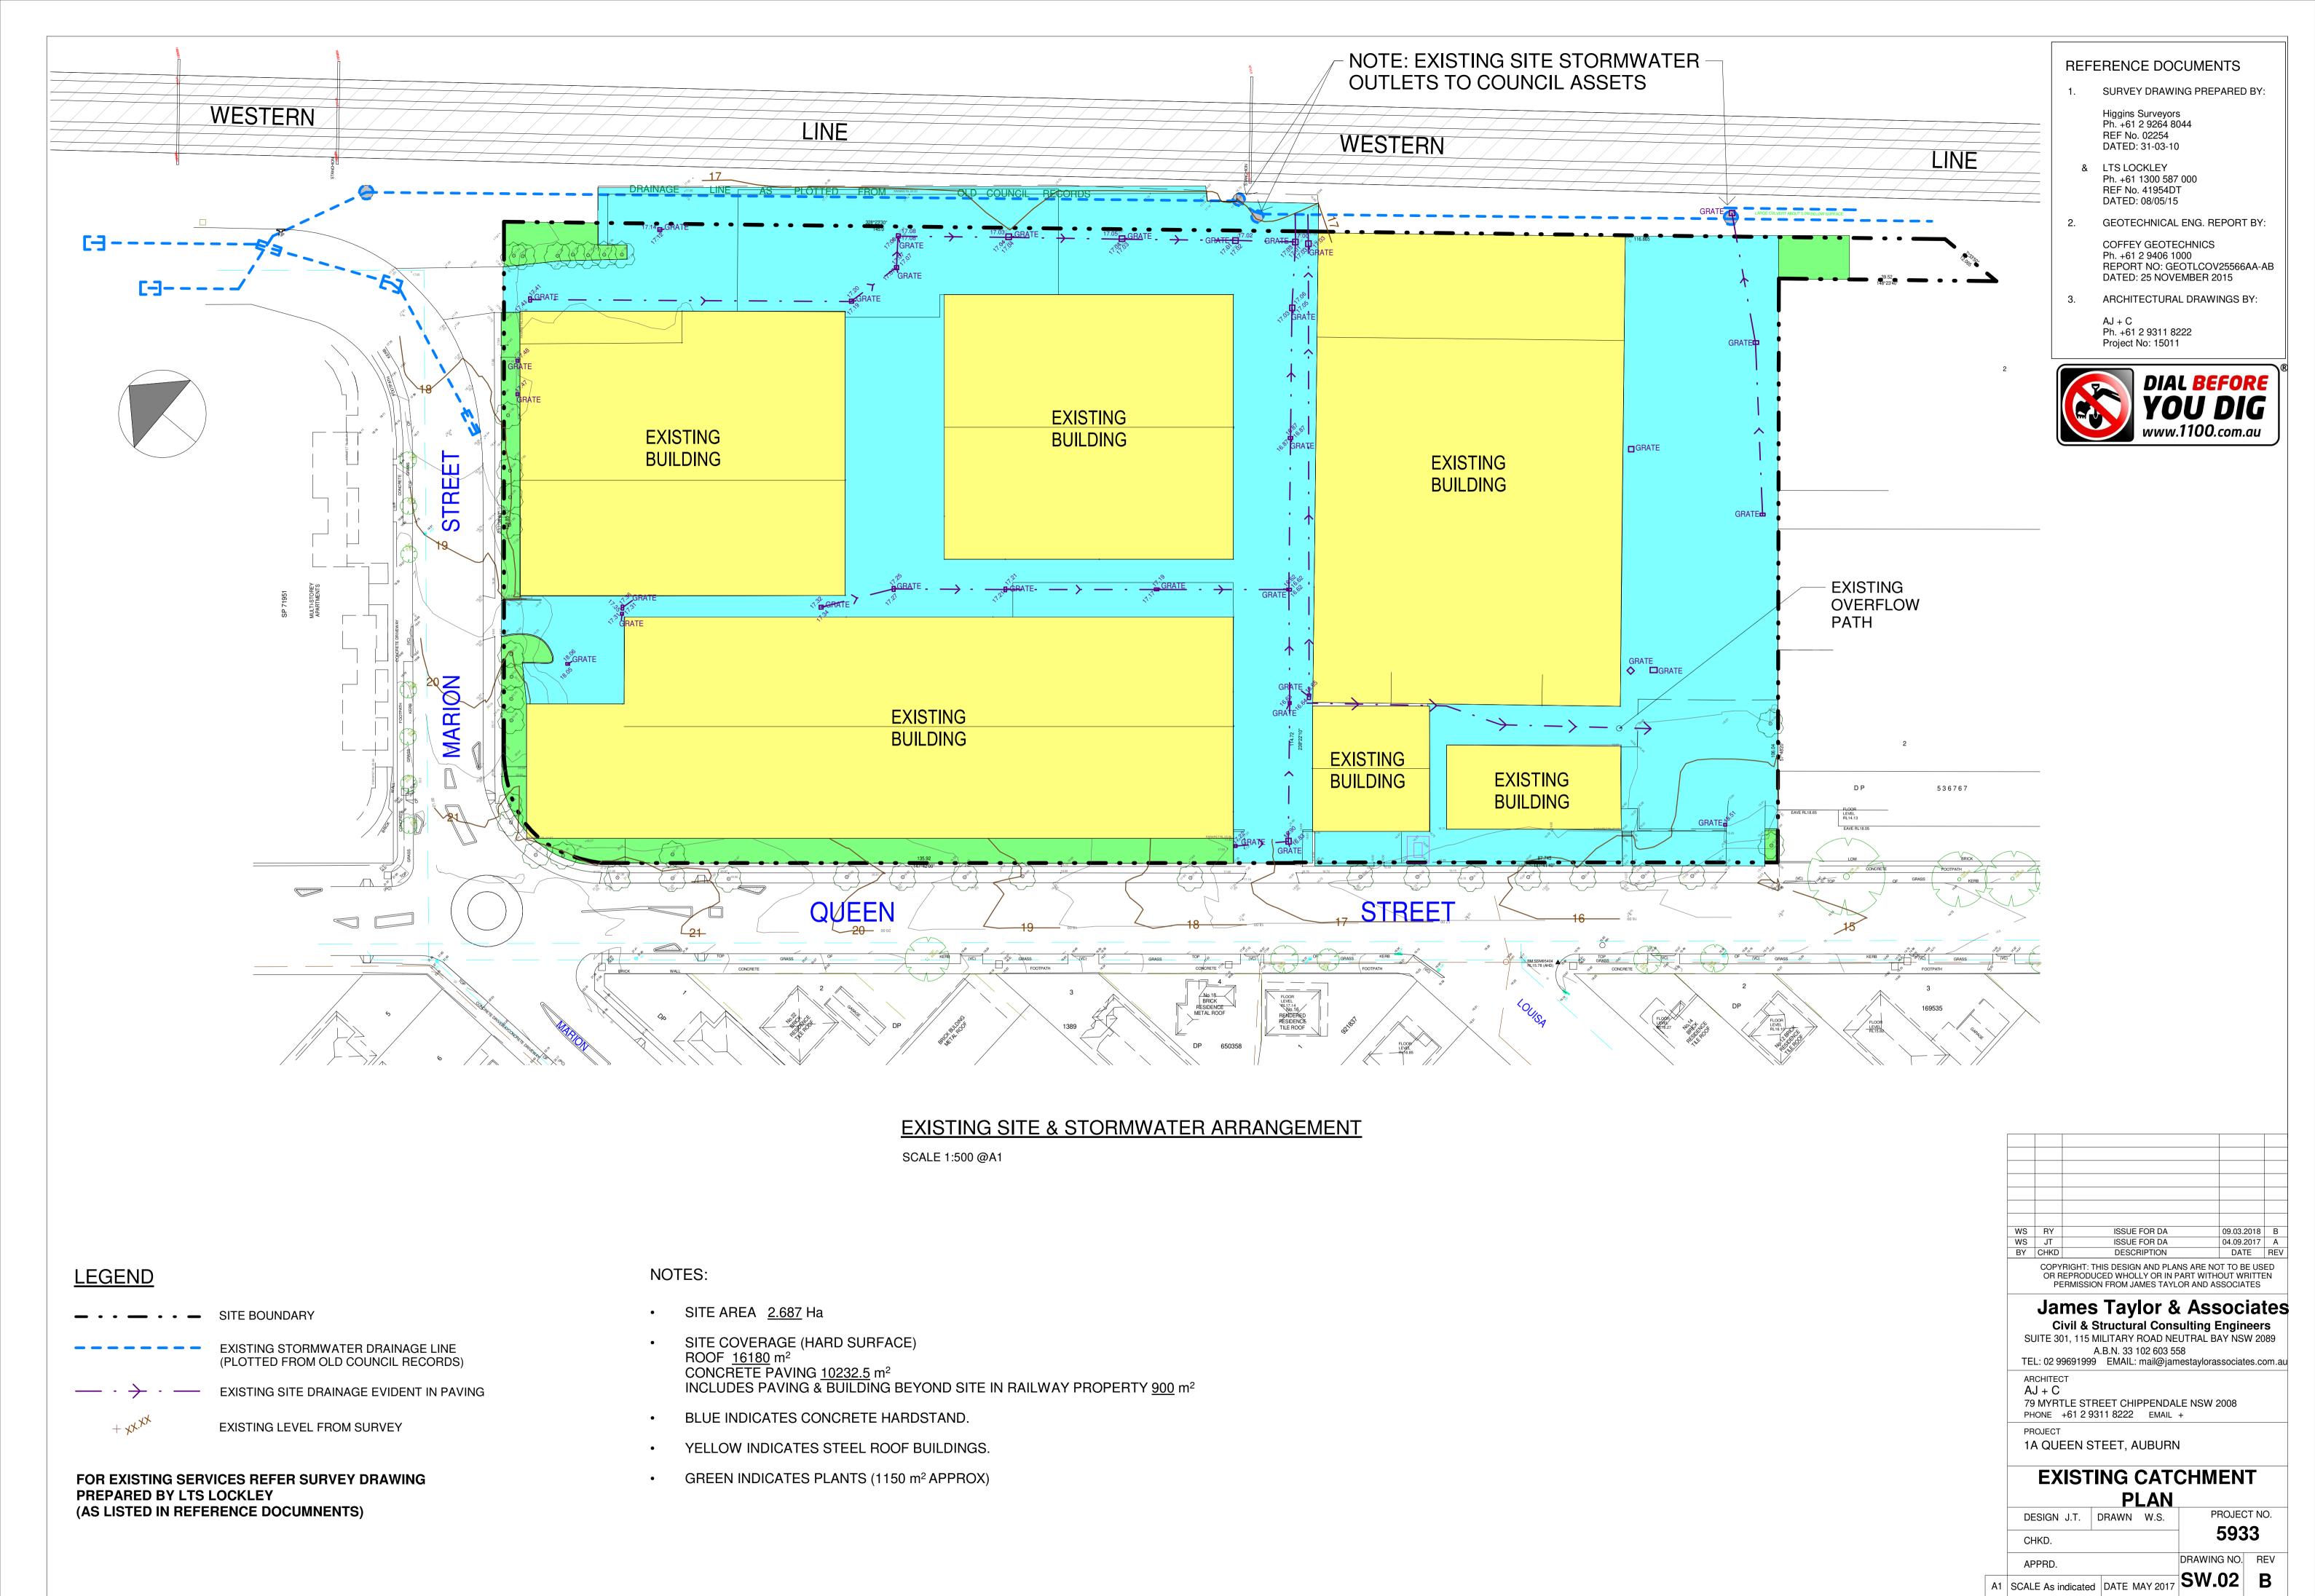


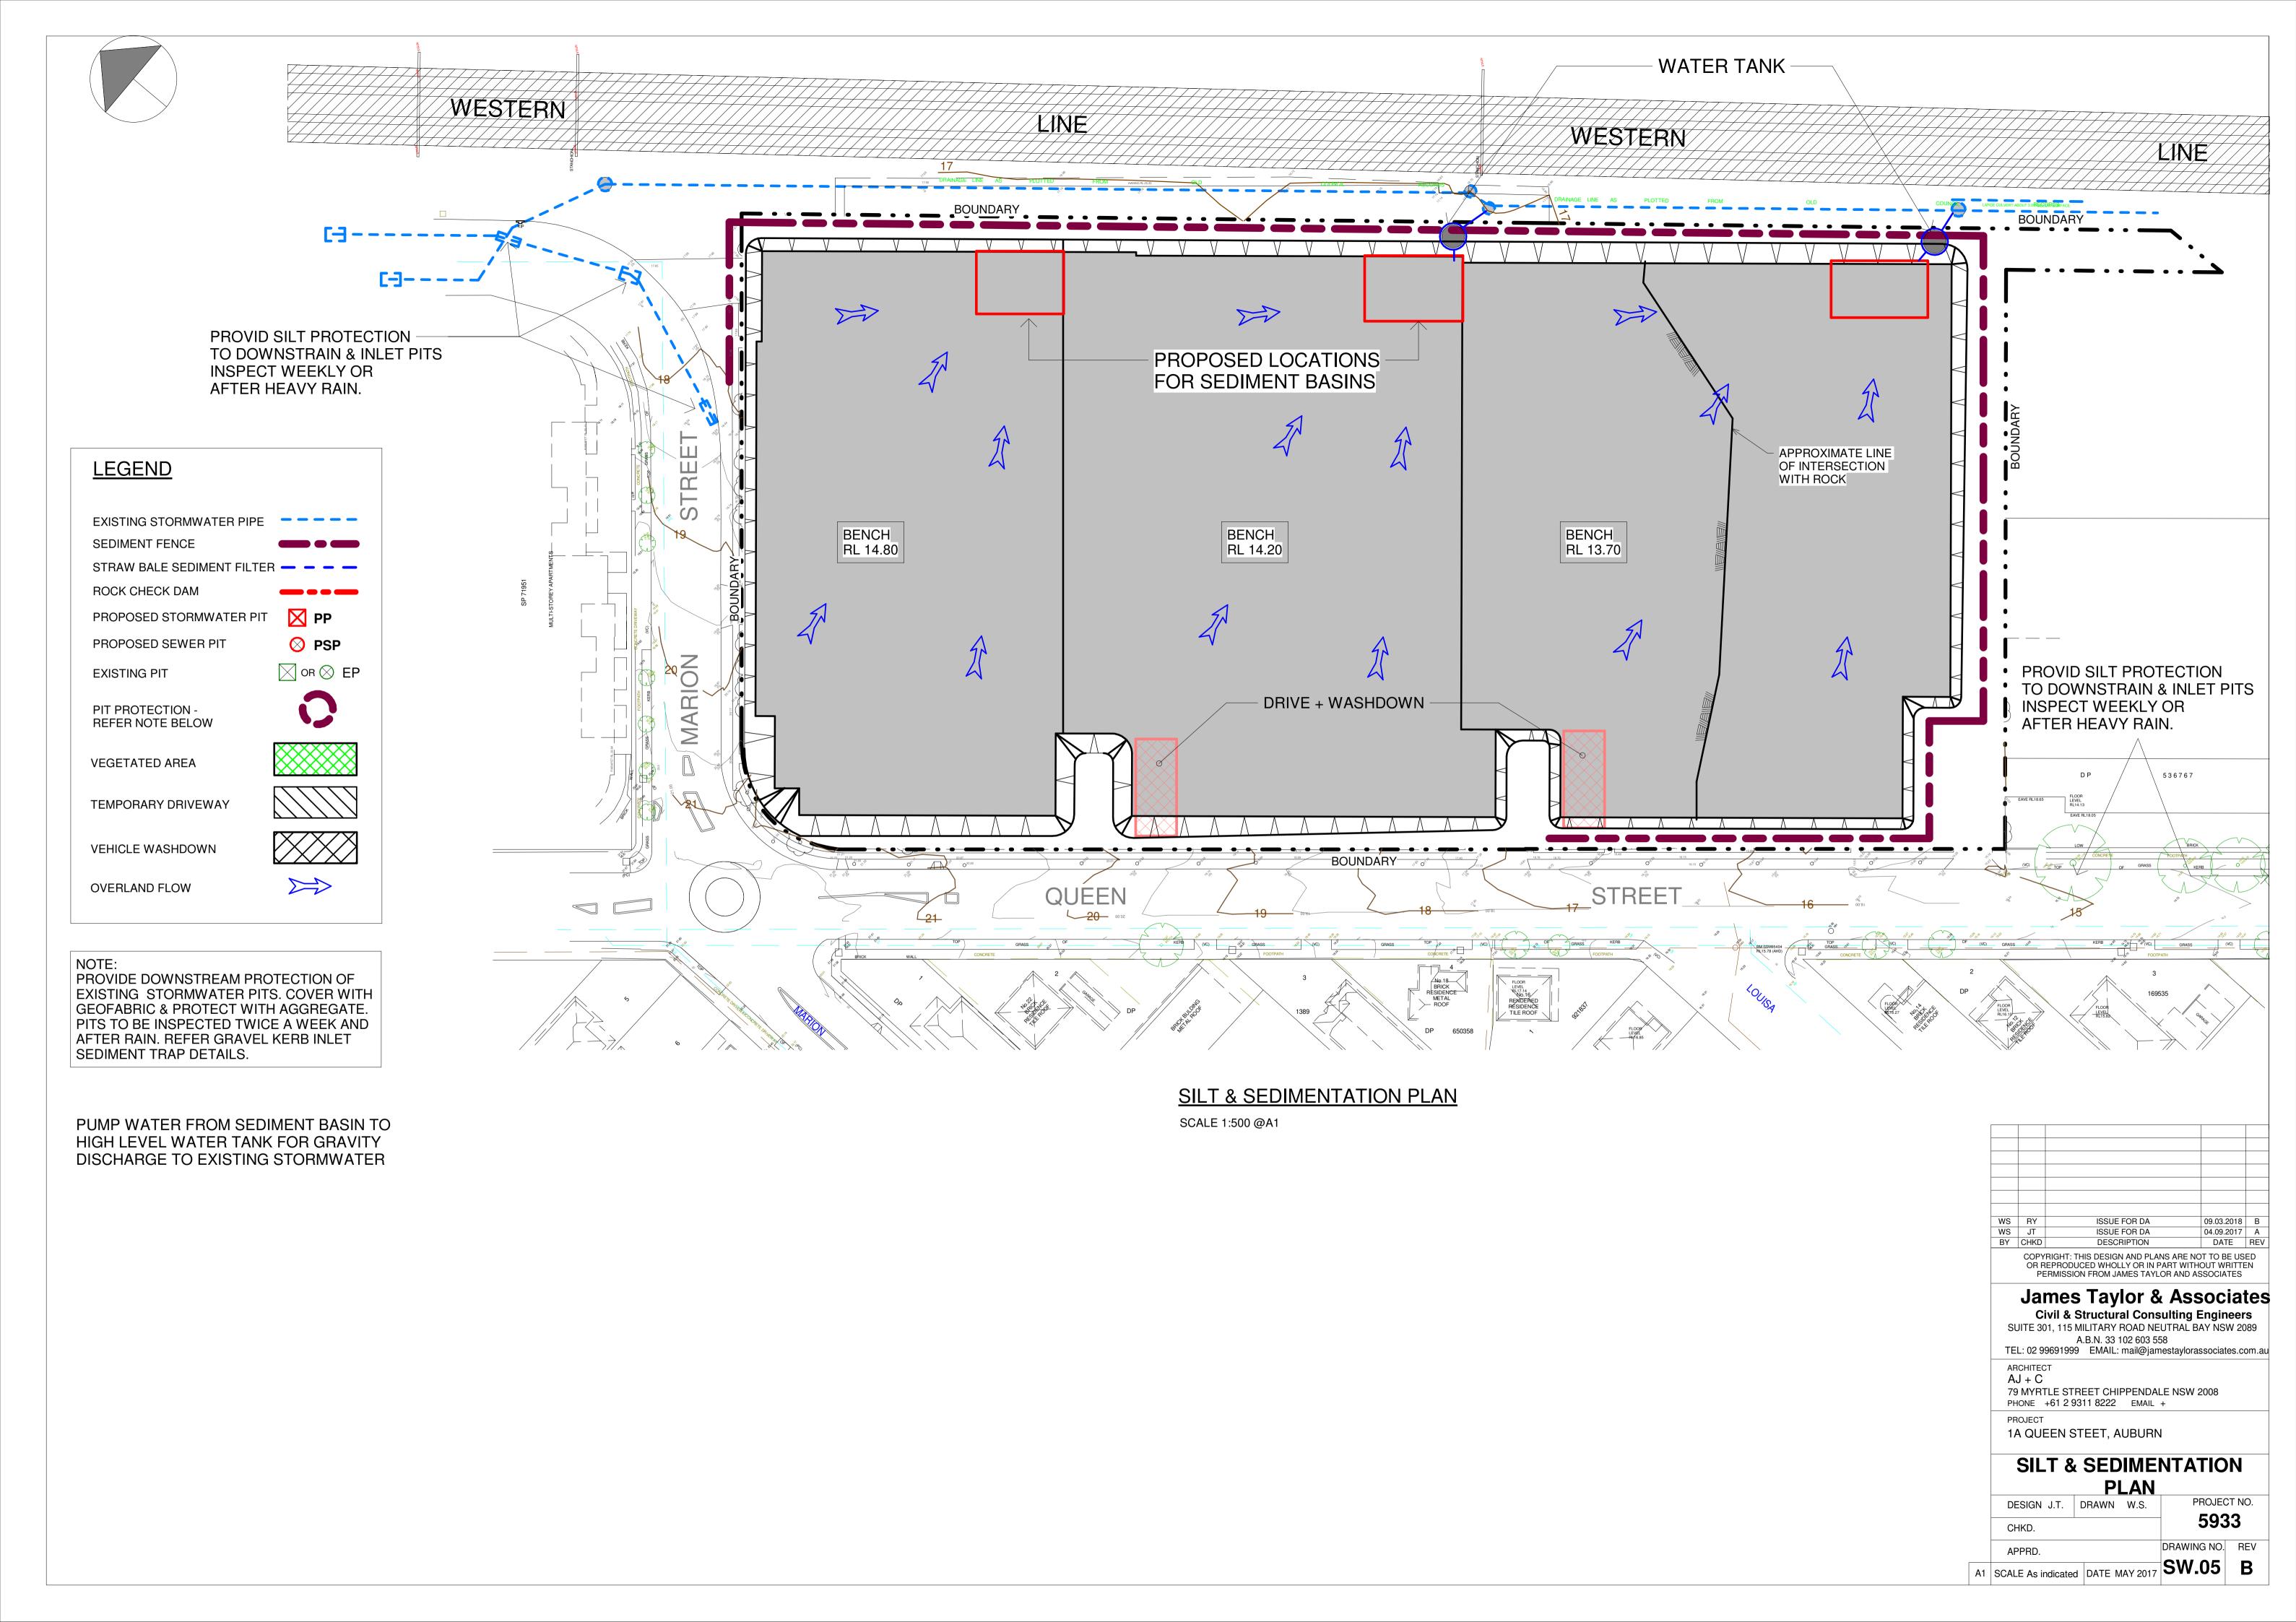


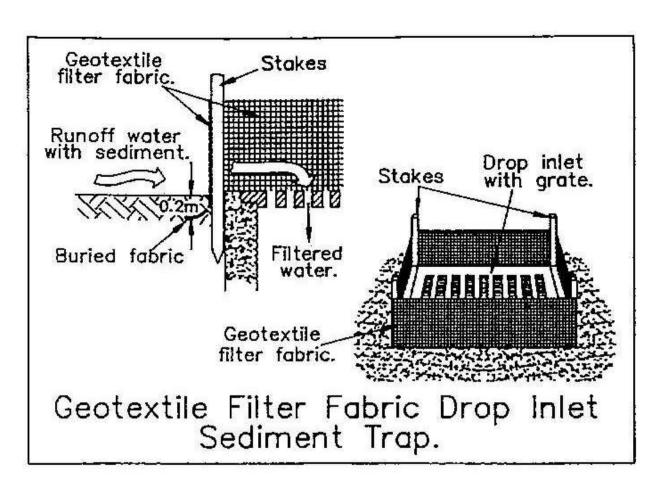


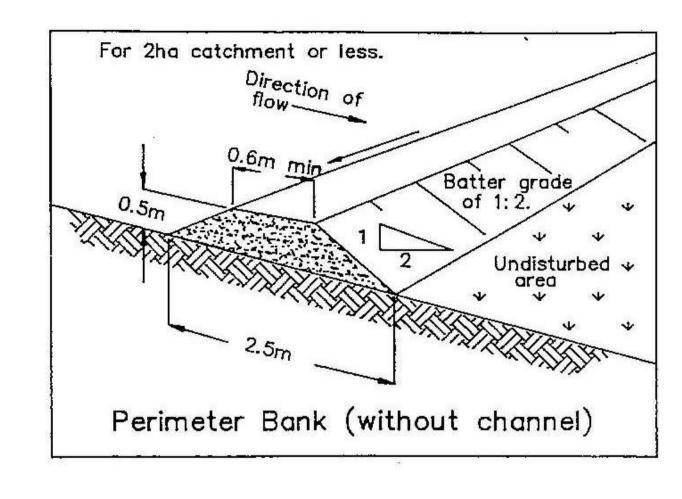


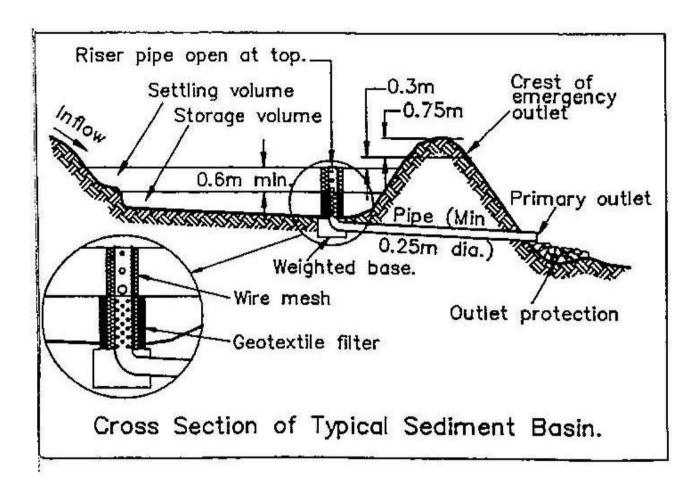


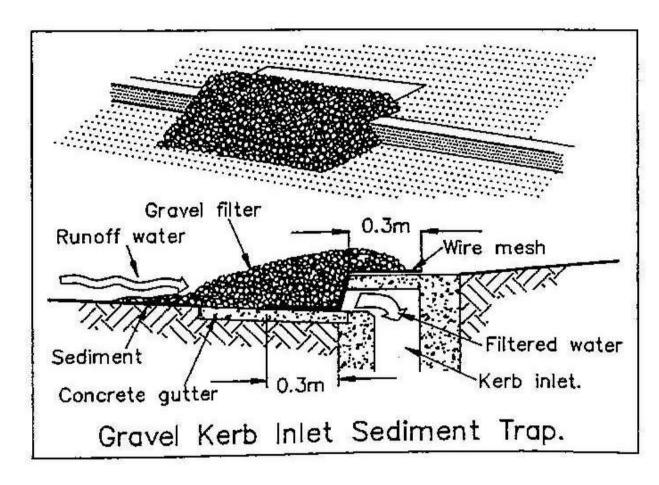


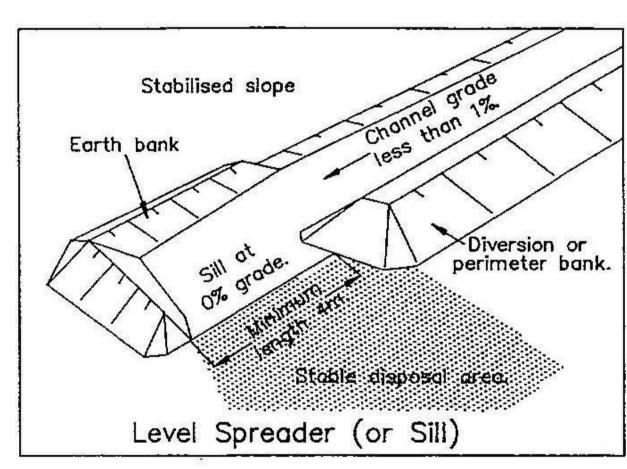


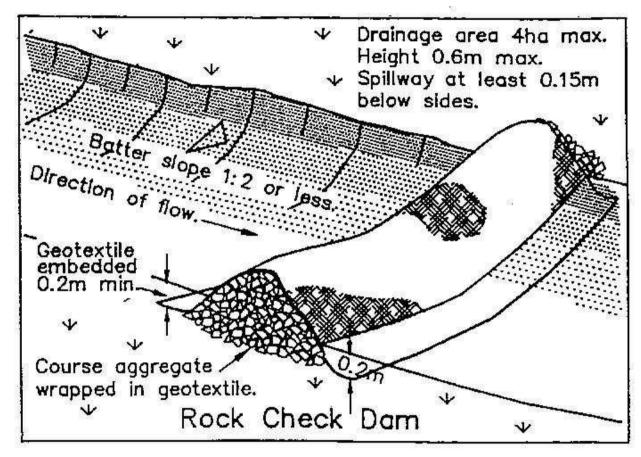

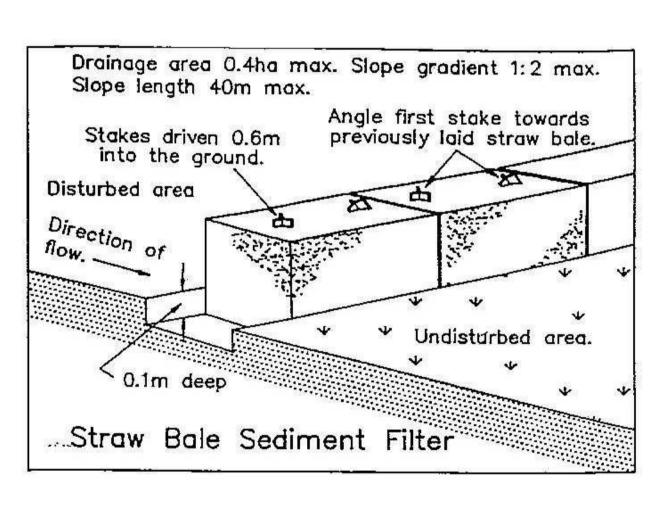

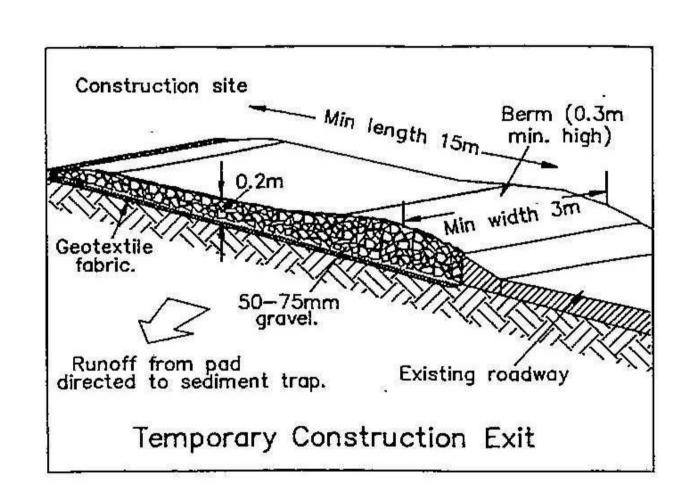

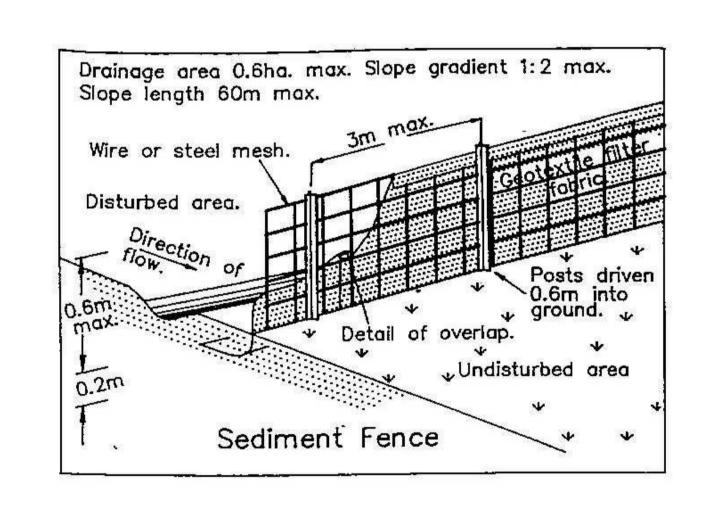

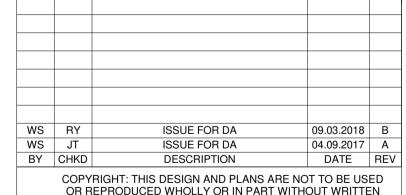

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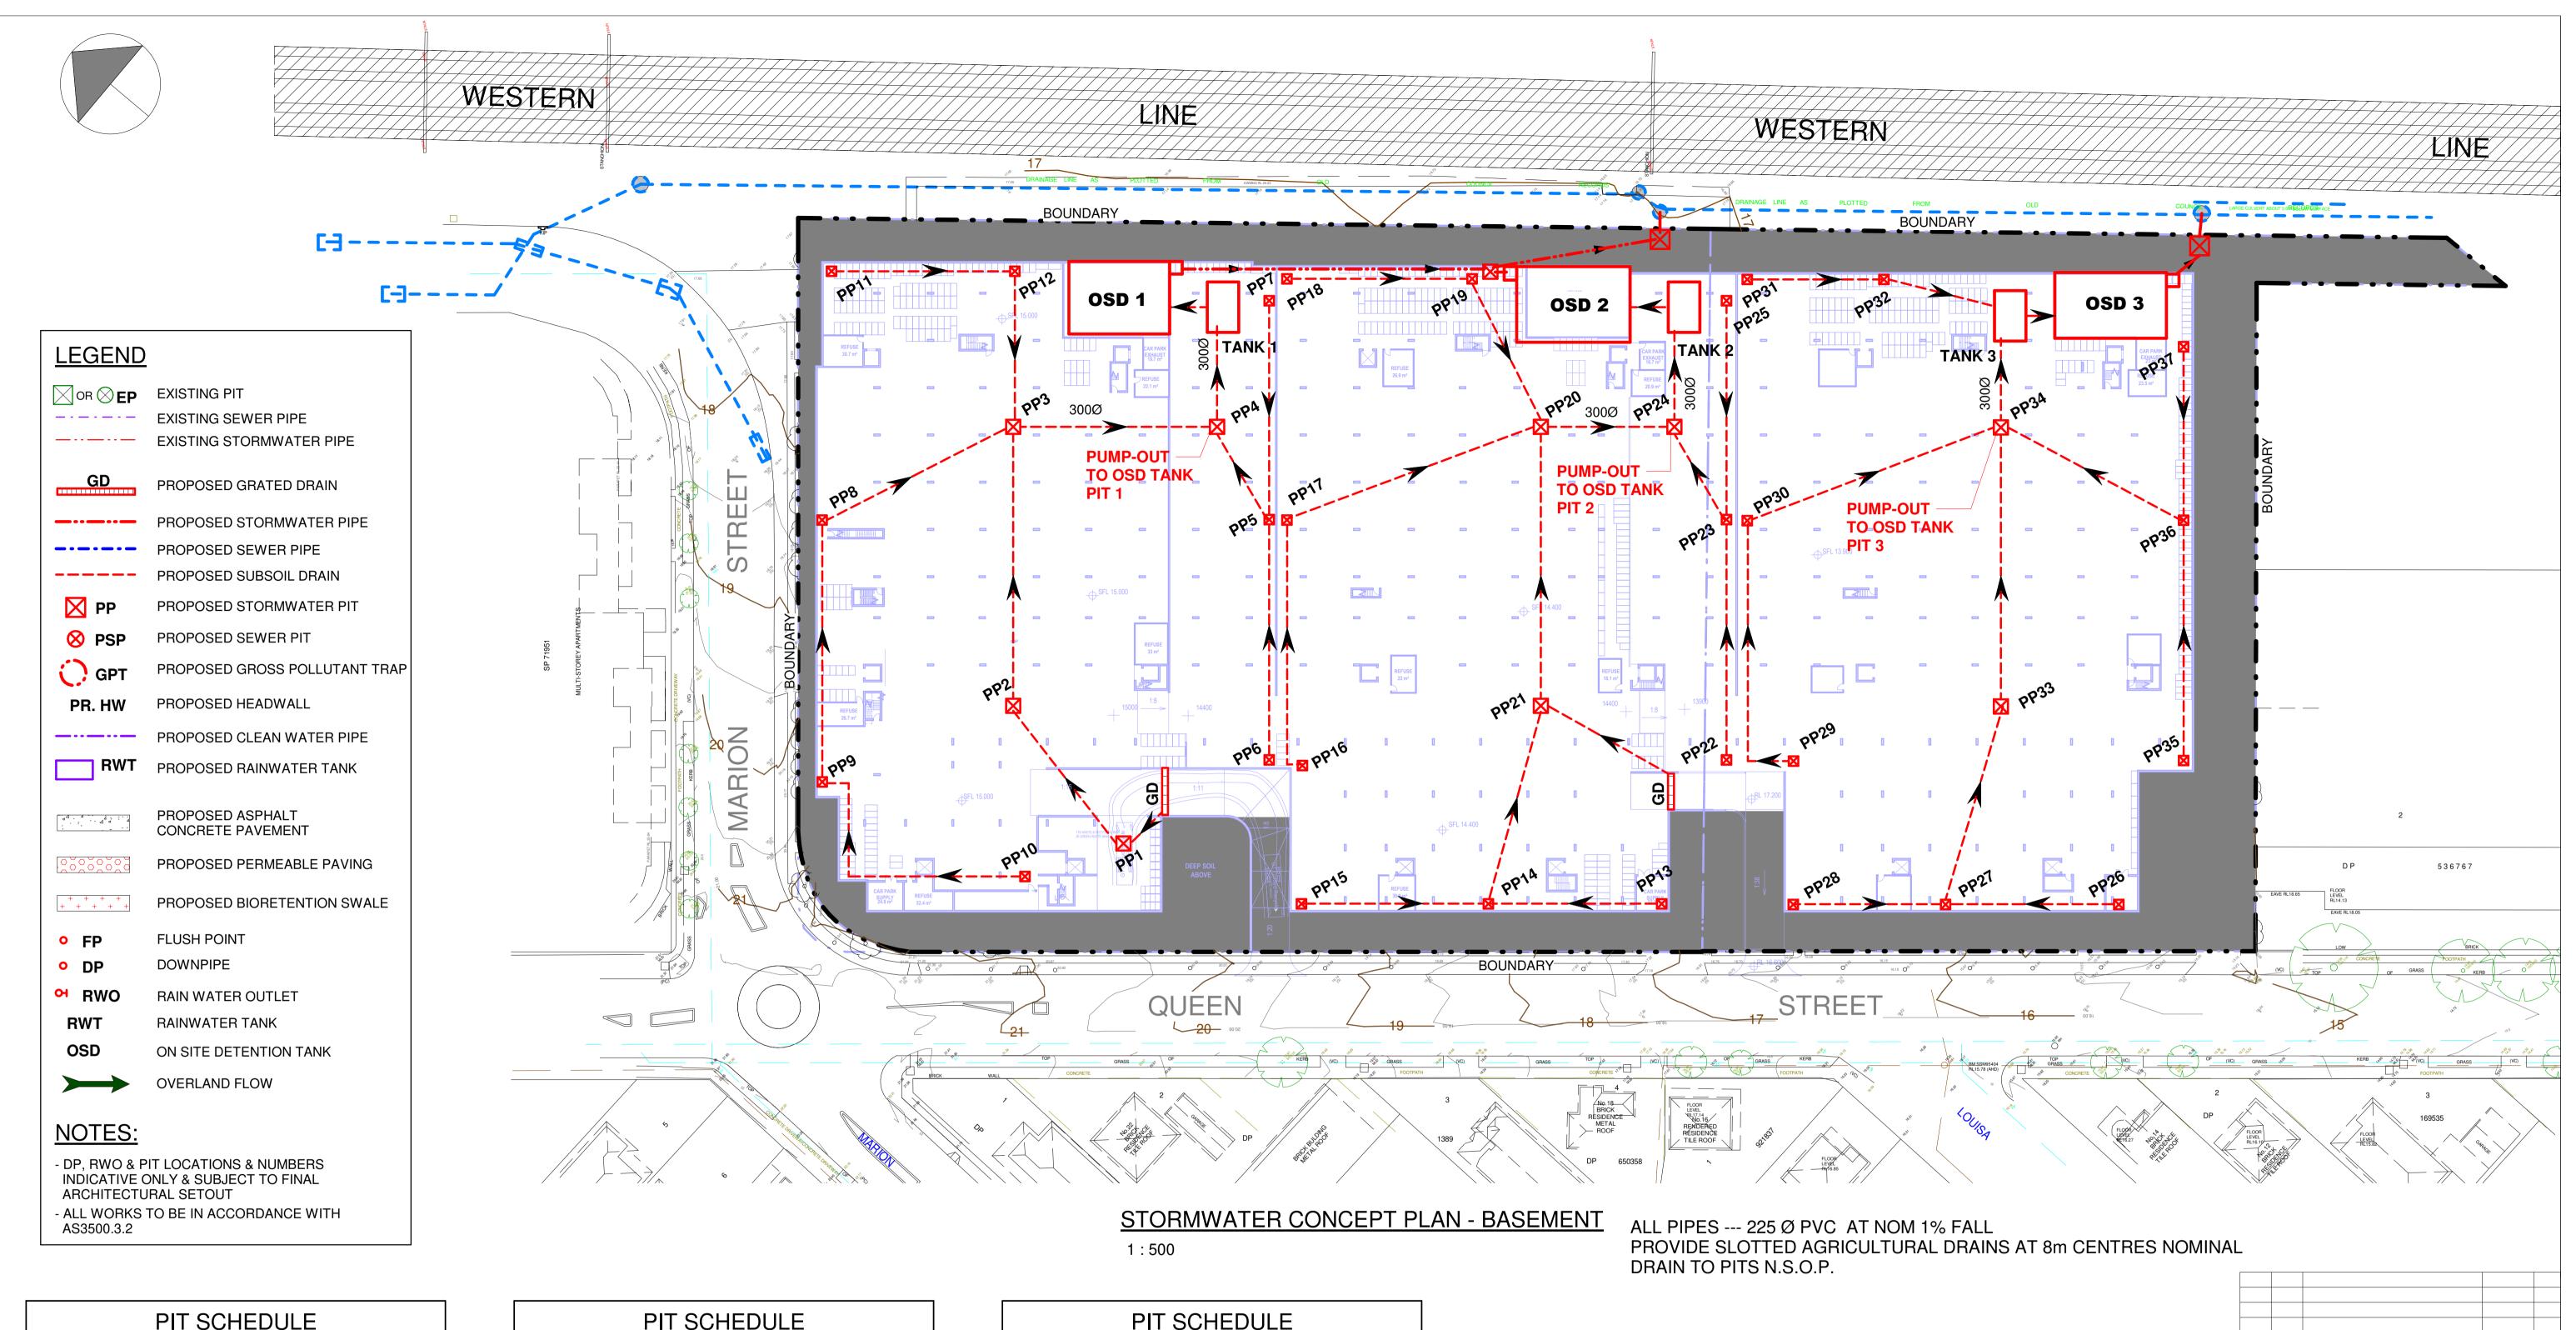
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1A QUEEN STEET, AUBURN

SILT & SEDIMENTATION DETAILS

	DESIGN J.T.	DRAWN W.	S.	PROJEC	CT NO.
	CHKD.			593	33
	APPRD.			DRAWING NO.	
A1	SCALE 1 : 15	DATE MAY 2	2017	SW.06	В



PIT SCHEDULE							
PIT No SIZE SURFACE INVERT LEVEL							
PP1	600×600	16.1	14.37	В			
PP2	600x600	14.97	14.09	В			
PP3	600×600	14.97	13.235	В			
PP4	900×900	14.37	12.925	В			
PP5	600x600	14.37	13.465	В			
PP6	600x600	14.37	13.845	В			
PP7	600x600	14.37	13.845	В			
PP8	600x600	14.97	13.565	В			
PP9	600x600	14.97	13.975	В			
PP10	600x600	14.97	14.445	В			
PP11	600x600	14.97	14.445	В			
PP12	600×600	14.97	14.155	В			

PIT SCHEDULE							
PIT No	SIZE	SURFACE LEVEL	INVERT LEVEL	GRATE CLASS			
PP13	600x600	14.37	13.845	В			
PP14	600x600	14.37	13.545	В			
PP15	600x600	14.37	13.845	В			
PP16	600x600	14.37	13.845	В			
PP17	600x600	14.37	13.445	В			
PP18	600x600	14.37	13.845	В			
PP19	600x600	14.37	13.555	В			
PP20	600x600	14.37	12.77	В			
PP21	600x600	14.37	13.215	В			
PP22	600x600	13.87	13.345	В			
PP23	600x600	13.87	12.965	В			
PP24	900x900	13.87	12.56	В			
PP25	600x600	13.87	13.345	В			

PIT SCHEDULE							
PIT No	SIZE	SURFACE LEVEL	INVERT LEVEL	GRATE CLASS			
PP26	600×600	13.87	13.345	В			
PP27	600x600	13.87	13.075	В			
PP28	600x600	13.87	13.345	В			
PP29	600x600	13.87	13.345	В			
PP30	600x600	13.87	12.85	В			
PP31	600x600	13.87	13.345	В			
PP32	600x600	13.87	13.115	В			
PP33	600x600	13.87	12.72	В			
PP34	900x900	13.87	12.27	В			
PP35	600x600	13.87	13.345	В			
PP36	600x600	13.87	12.965	В			
PP37	600x600	13.87	13.345	В			

PUMP OUT TANK SCHEDULE					
TANK No	VOLUME	PUMP CAPACITY			
TANK 1	80m³	18 L/s			
TANK 2	80m³	18 L/s			
TANK 3	80m³	18 L/s			

NOTE:
PP1, PP2 CONTAIN "STORMWATER 360 ENVIROPOD OILSORB" INSERTS
FOR OIL & TRASH REMOVAL

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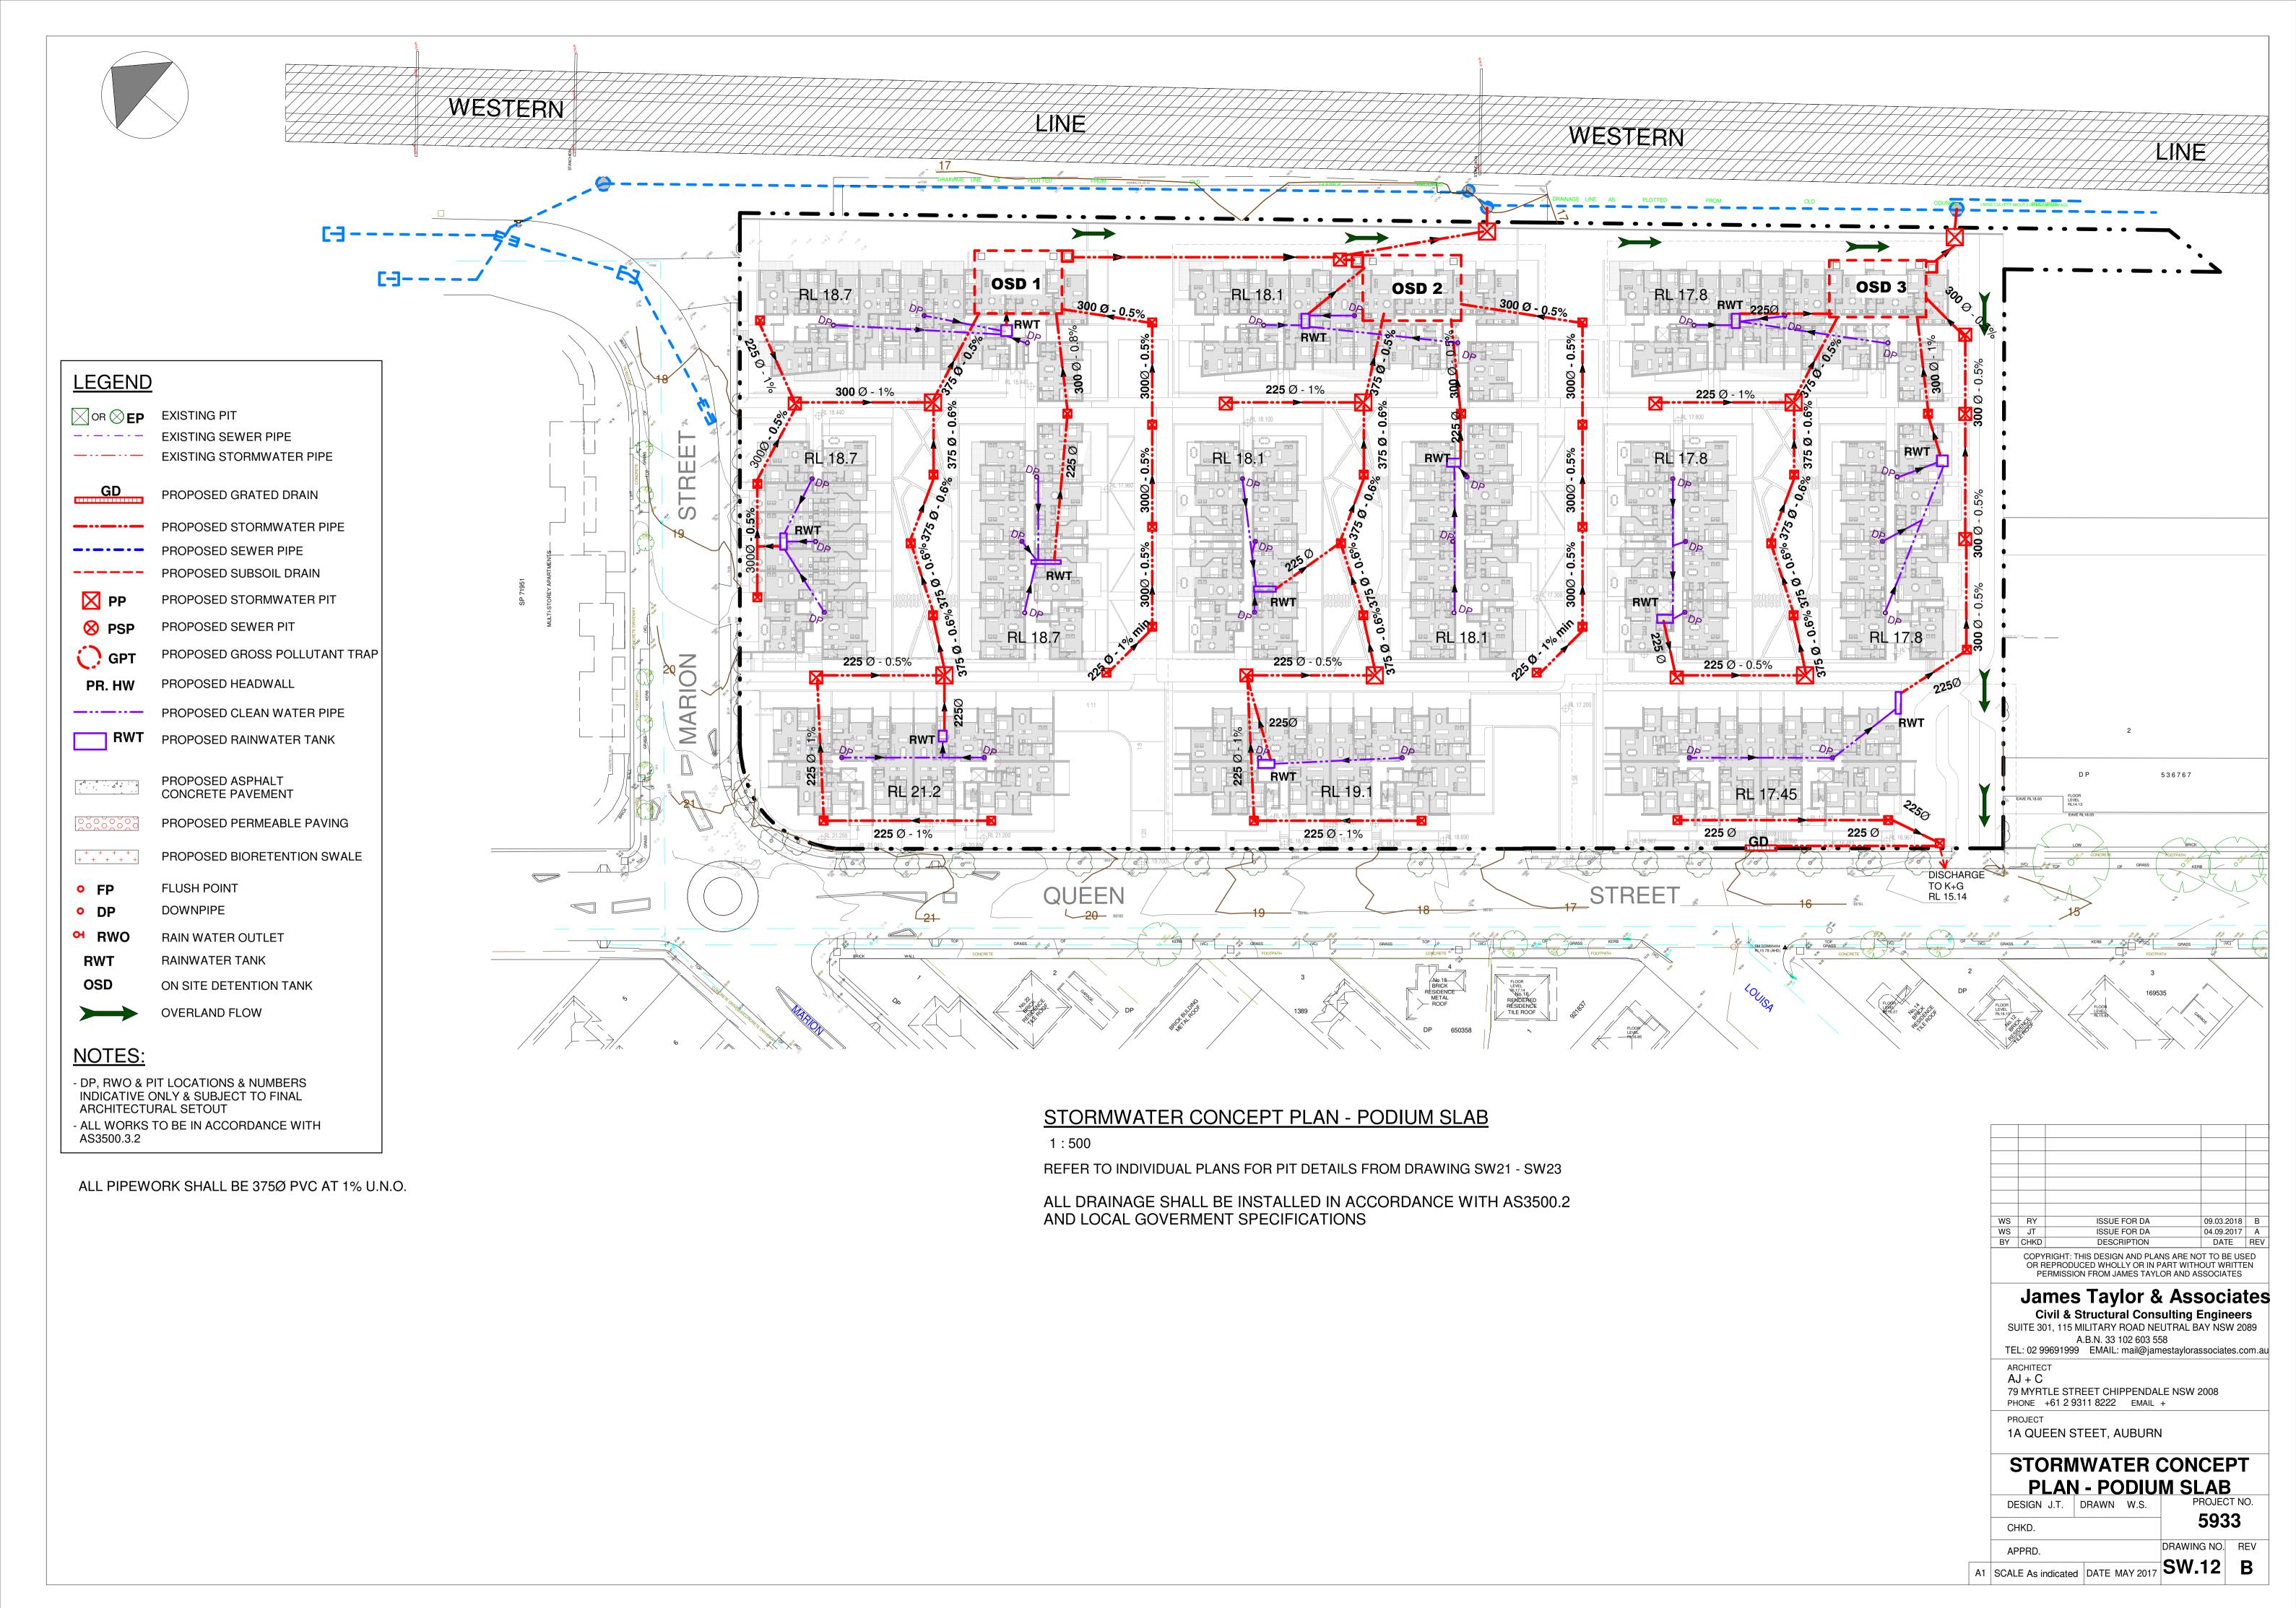
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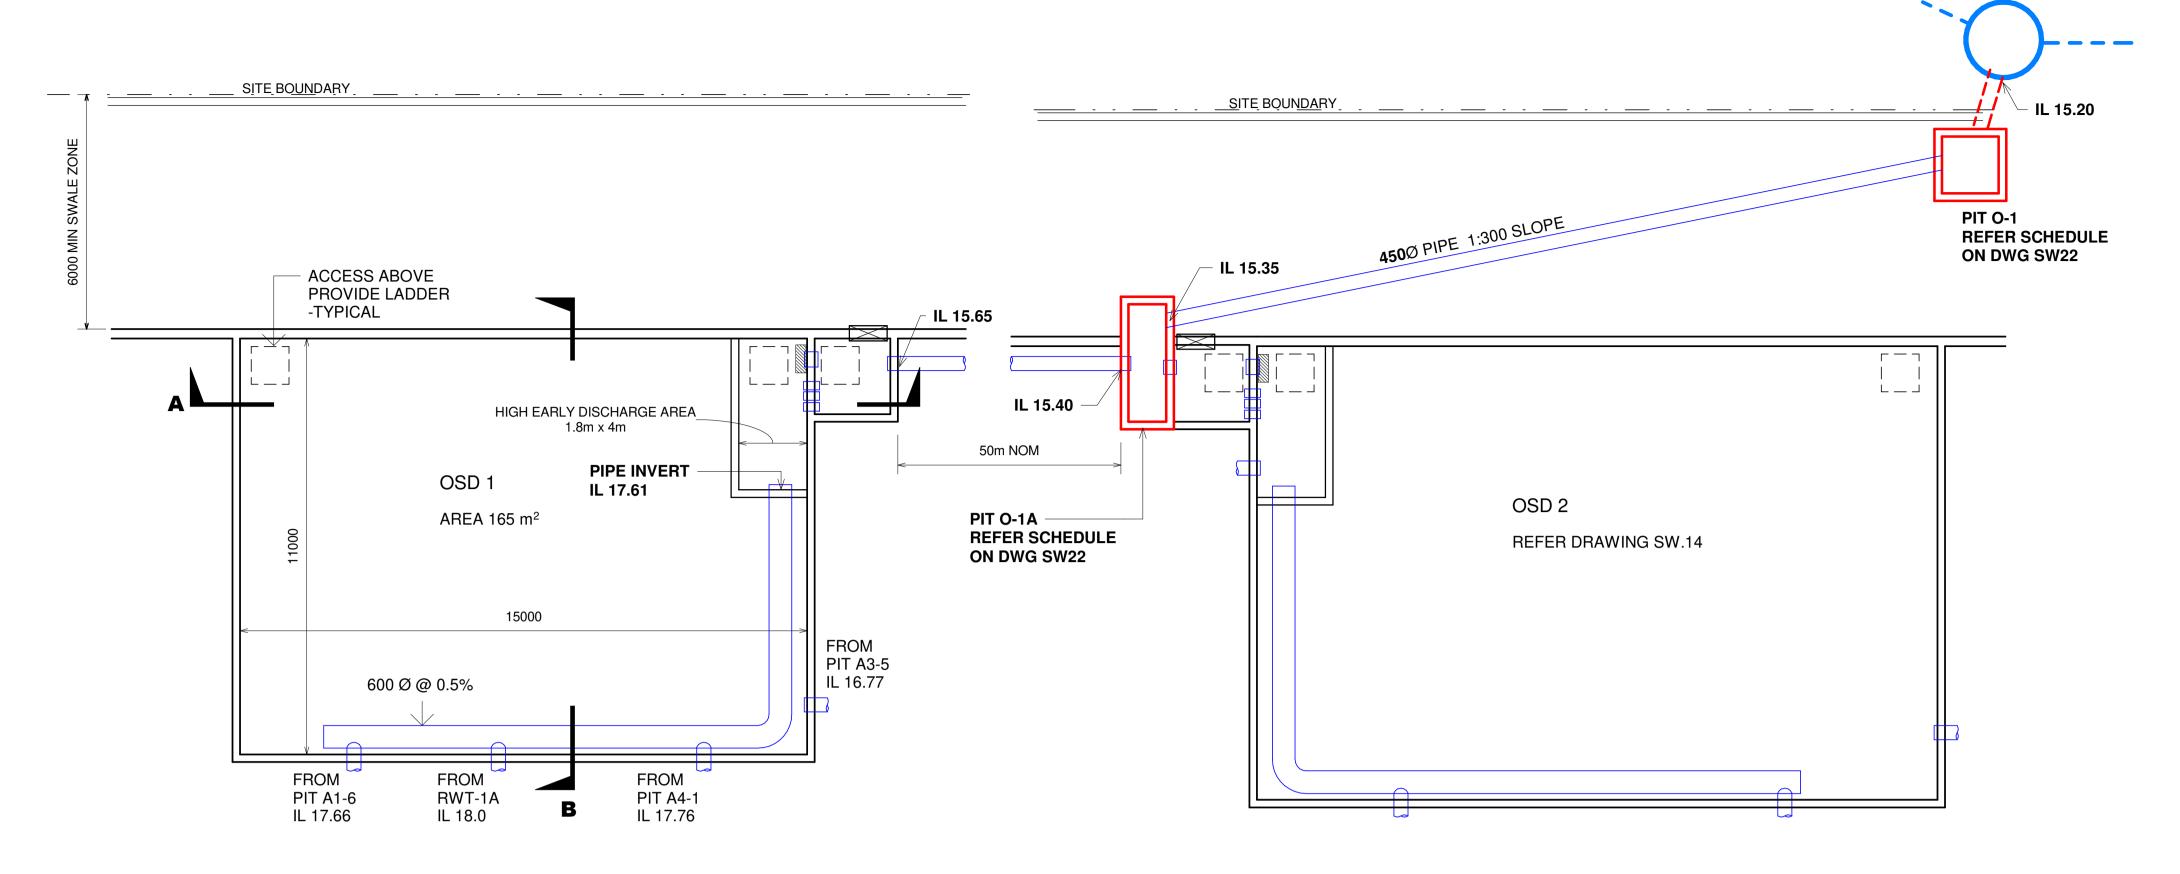
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STORMWATER CONCEPT

PLAN - BASEMENT					
DESIGN J.T.	DRAWN	W.S.	PROJEC	CT NO.	
CHKD.			593	33	
APPRD.			DRAWING NO.	REV	
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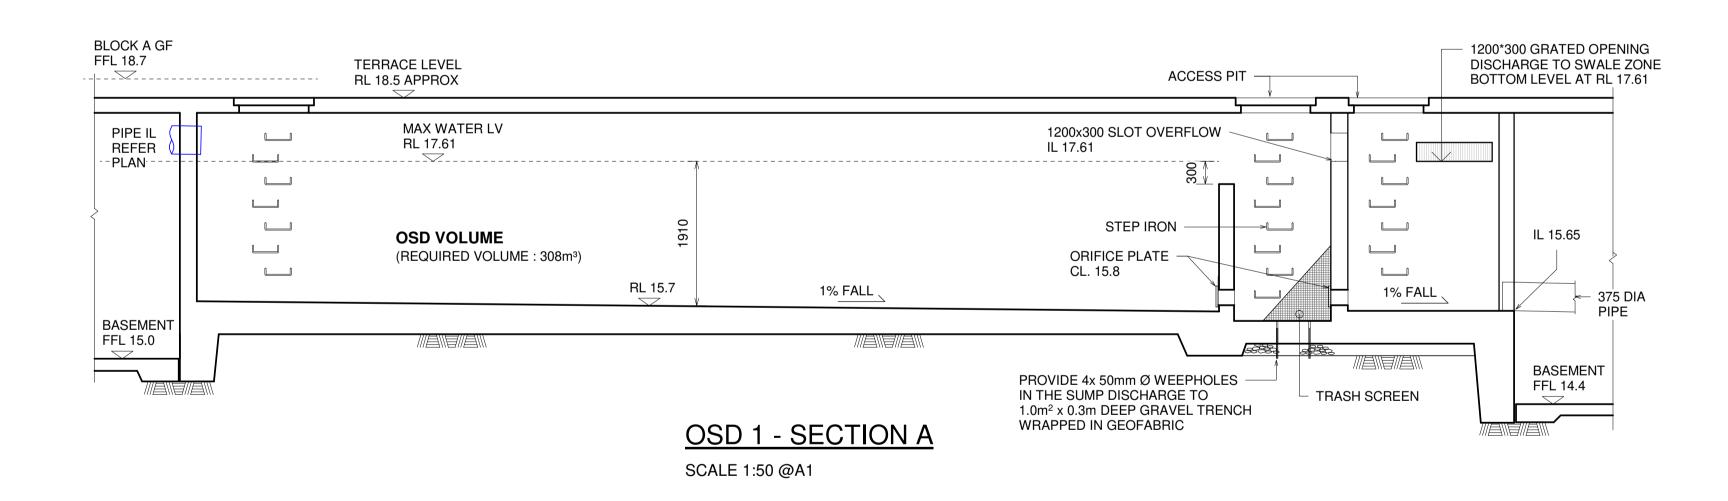
A1 SCALE As indicated DATE MAY 2017 SW.11 B






OSD 1&2 PLAN

SCALE 1:100 @A1



OSD 1 ORIFICE DIAMETER: 176 mm

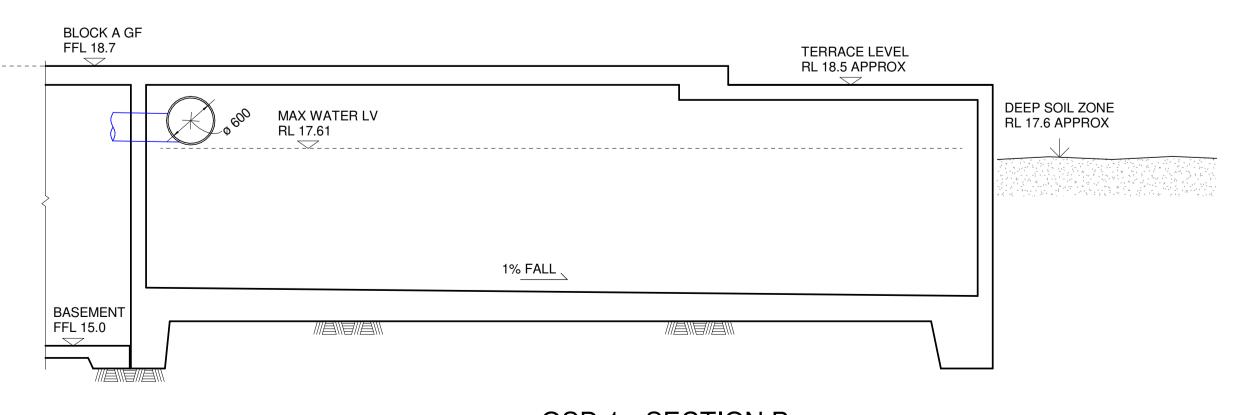

OSD 1 - SECTION B

SCALE 1:50 @A1

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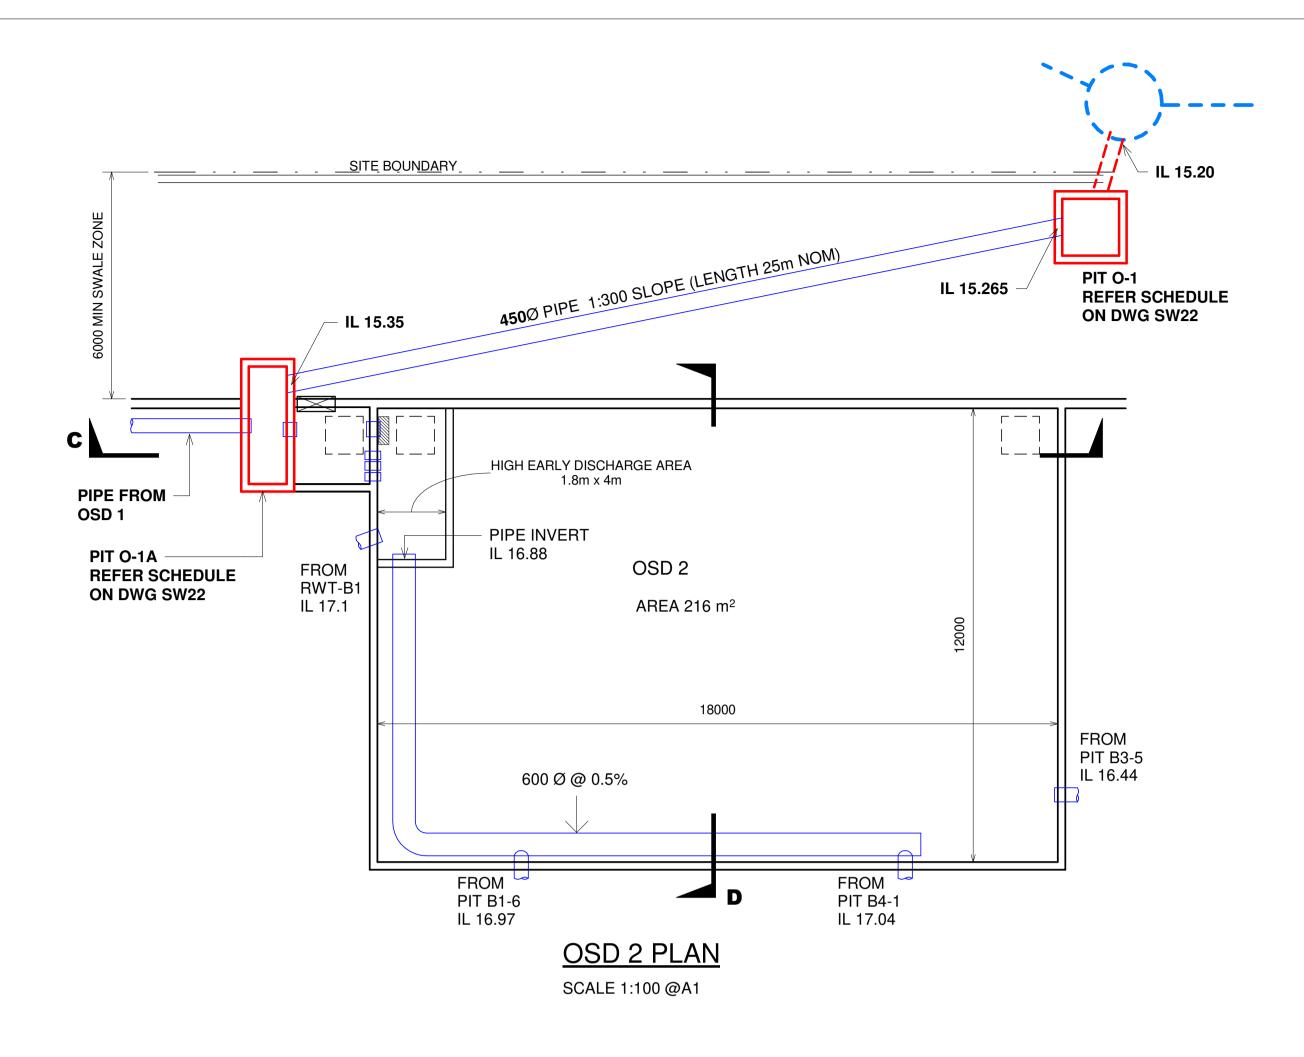
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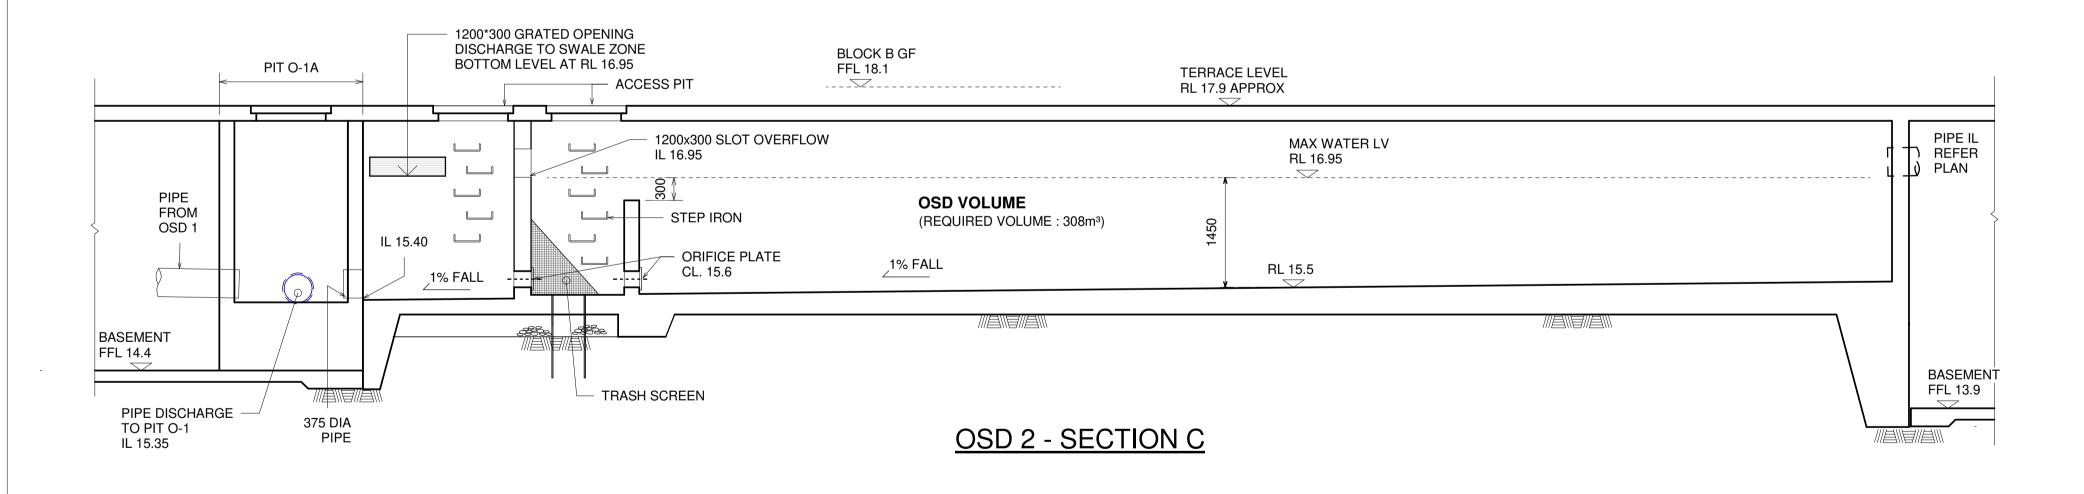
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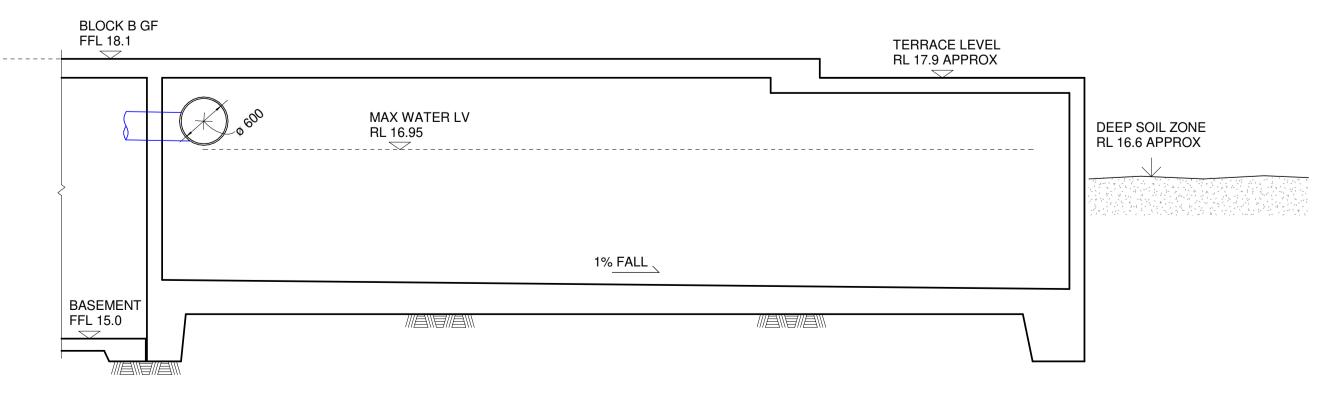
OSD 1 PLAN & SECTIONS

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	CHKD.			593	33
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	APPRD.			DRAWING NO.	
	SCALE As indicated			SW 13	В
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OSD 2 ORIFICE DIAMETER: 214 mm



OSD 2 - SECTION D SCALE 1:50 @A1

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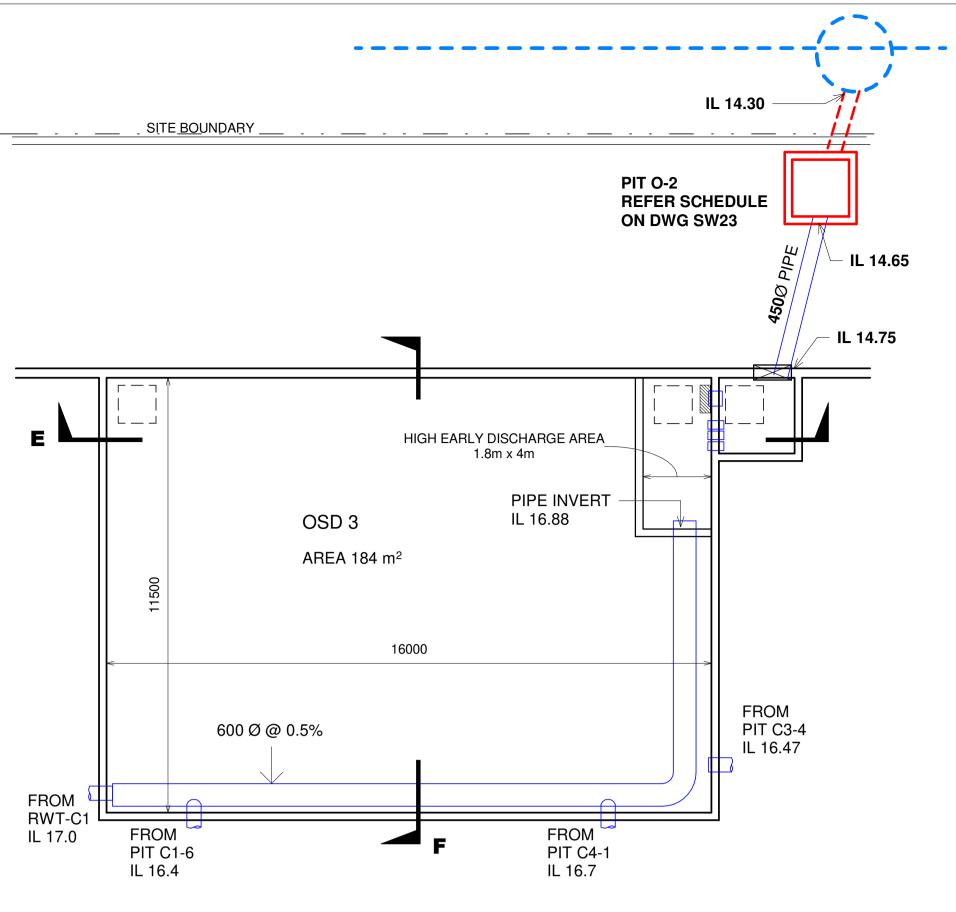
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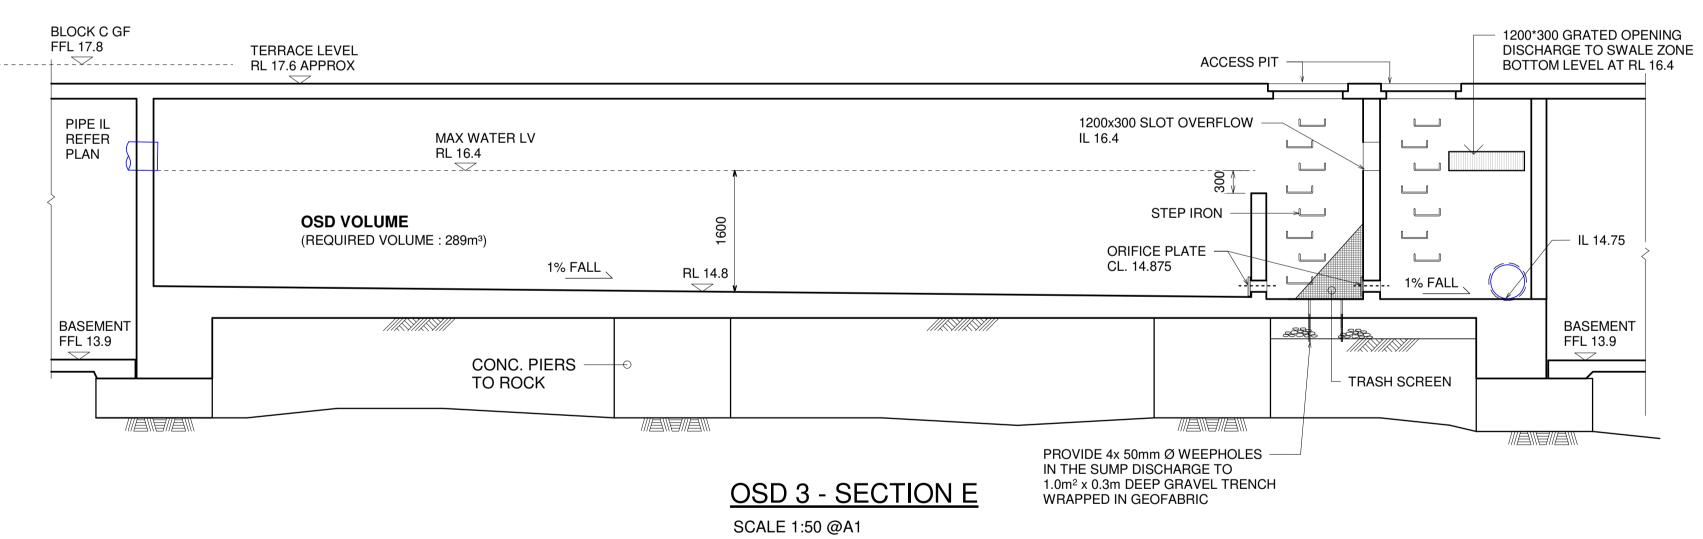
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OSD 2 PLAN & SECTIONS


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		CHKD.			593	33
		APPRD.			DRAWING NO.	
	A1 SCALE As indicated		DATE	MAY 2017	SW.14	Α



OSD 3 PLAN SCALE 1:100 @A1



OSD 3 ORIFICE DIAMETER: 152 mm

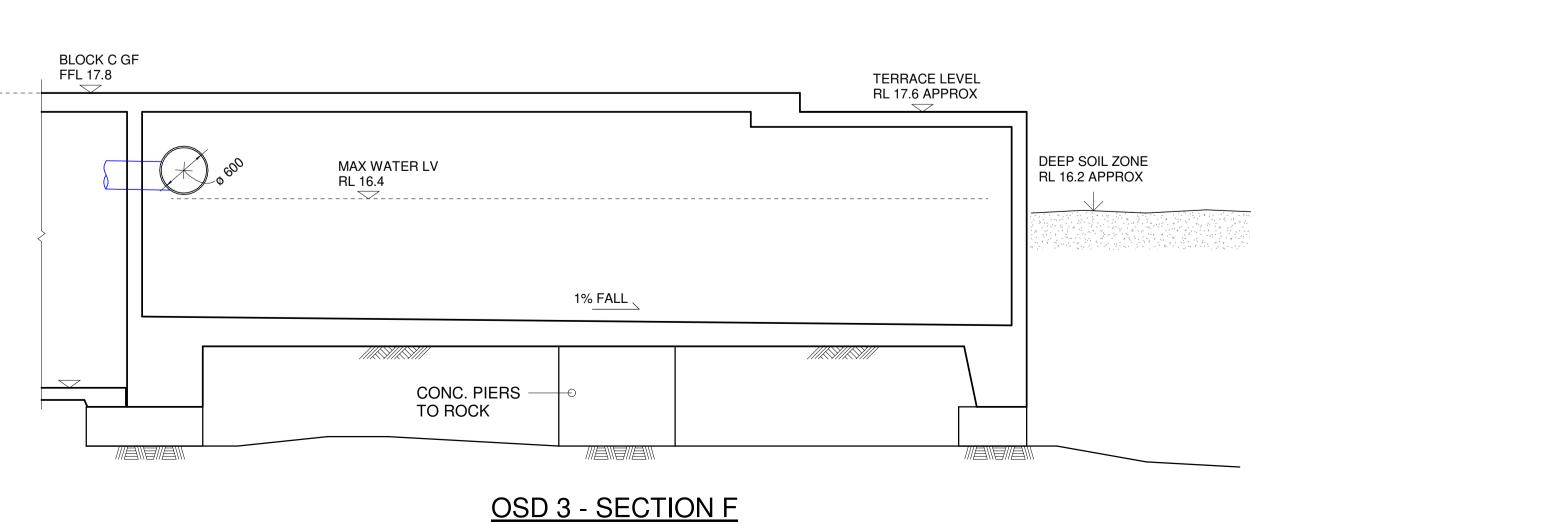

SCALE 1:50 @A1

OSD 3 PLAN & SECTIONS

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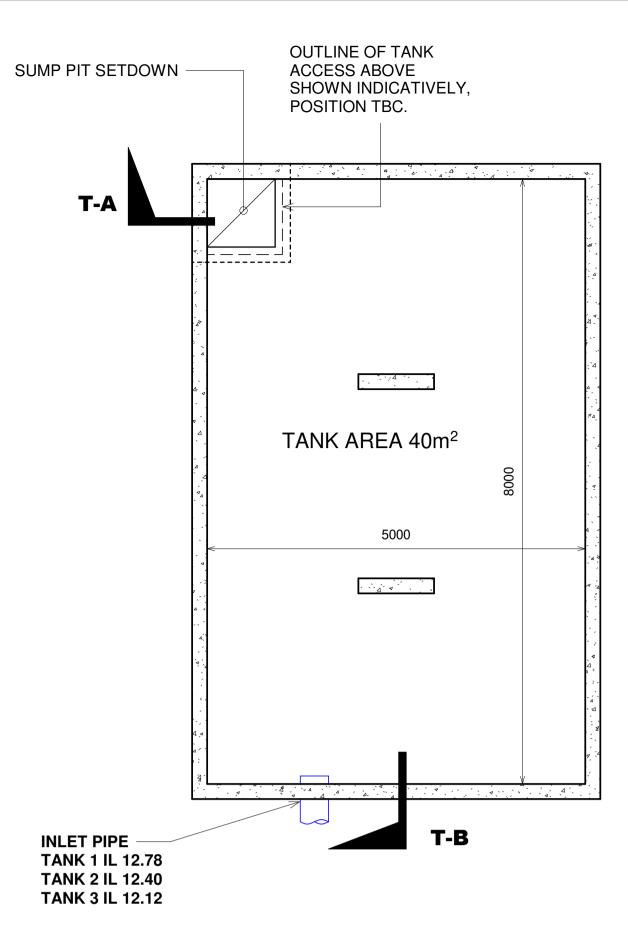
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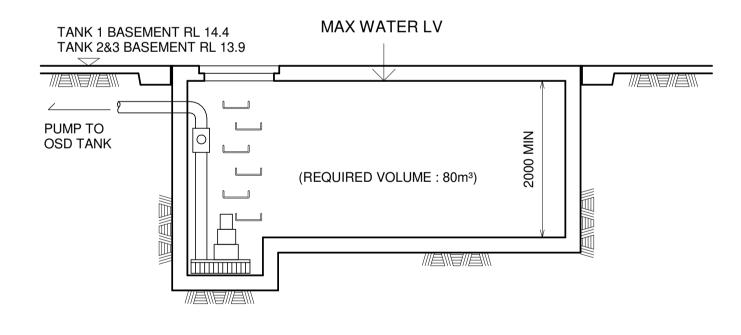
SCALE As indicated DATE MAY 2017

AND SCALE As indicated DATE MAY 2017

ARCHITECT AJ + C



PUMP OUT TANK TYPICAL PLAN



SECTION T-A

BASEMENT STORAGE CALCULATIONS

TANK 1 & 2 & 3 (PER TANK)

CATCHMENT AREA = 282 m^2 (PER TANK)

100 ARI 90 MIN INTENSITY = 57.1 mm/hr

PRIMARY STORAGE = 24 m³ (PER TANK)

100 ARI 12 hr INTENSITY = 16.7 mm/hr

SECONDARY STORAGE = 54 m³ (PER TANK)

TOTAL STORAGE = 78 m^3 (PER TANK)

PUMP CAPACITY:

- ARI 100 5 MIN INTENSITY = 228 mm/hr


- RATE = $64 \text{ m}^3/\text{hr} = 18 \text{ L/s}$

NOTE:

2 TANKS REQUIRED.

3 TANKS SUPPLIED TO SUIT CONSTRUCT STAGING

STORAGE VOLUME SUPPLIED = 240 m³

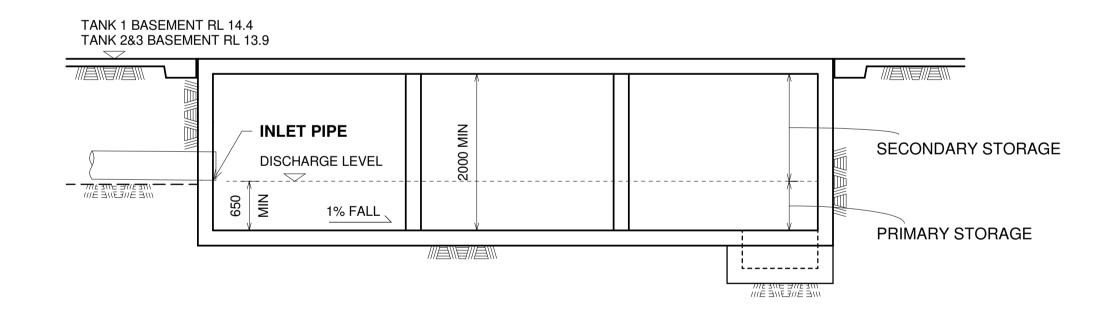

SECTION T-B

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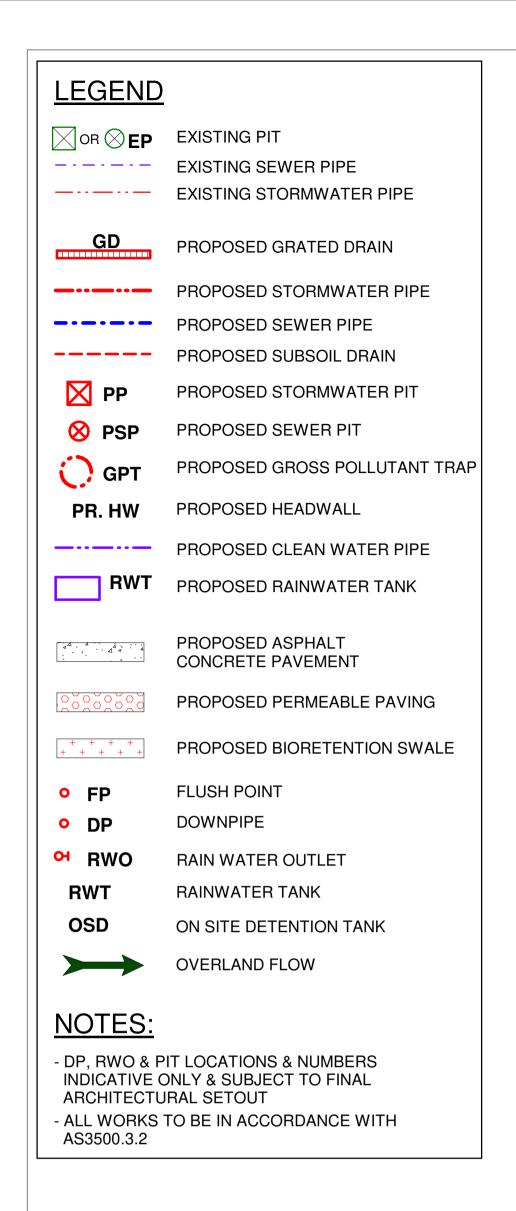
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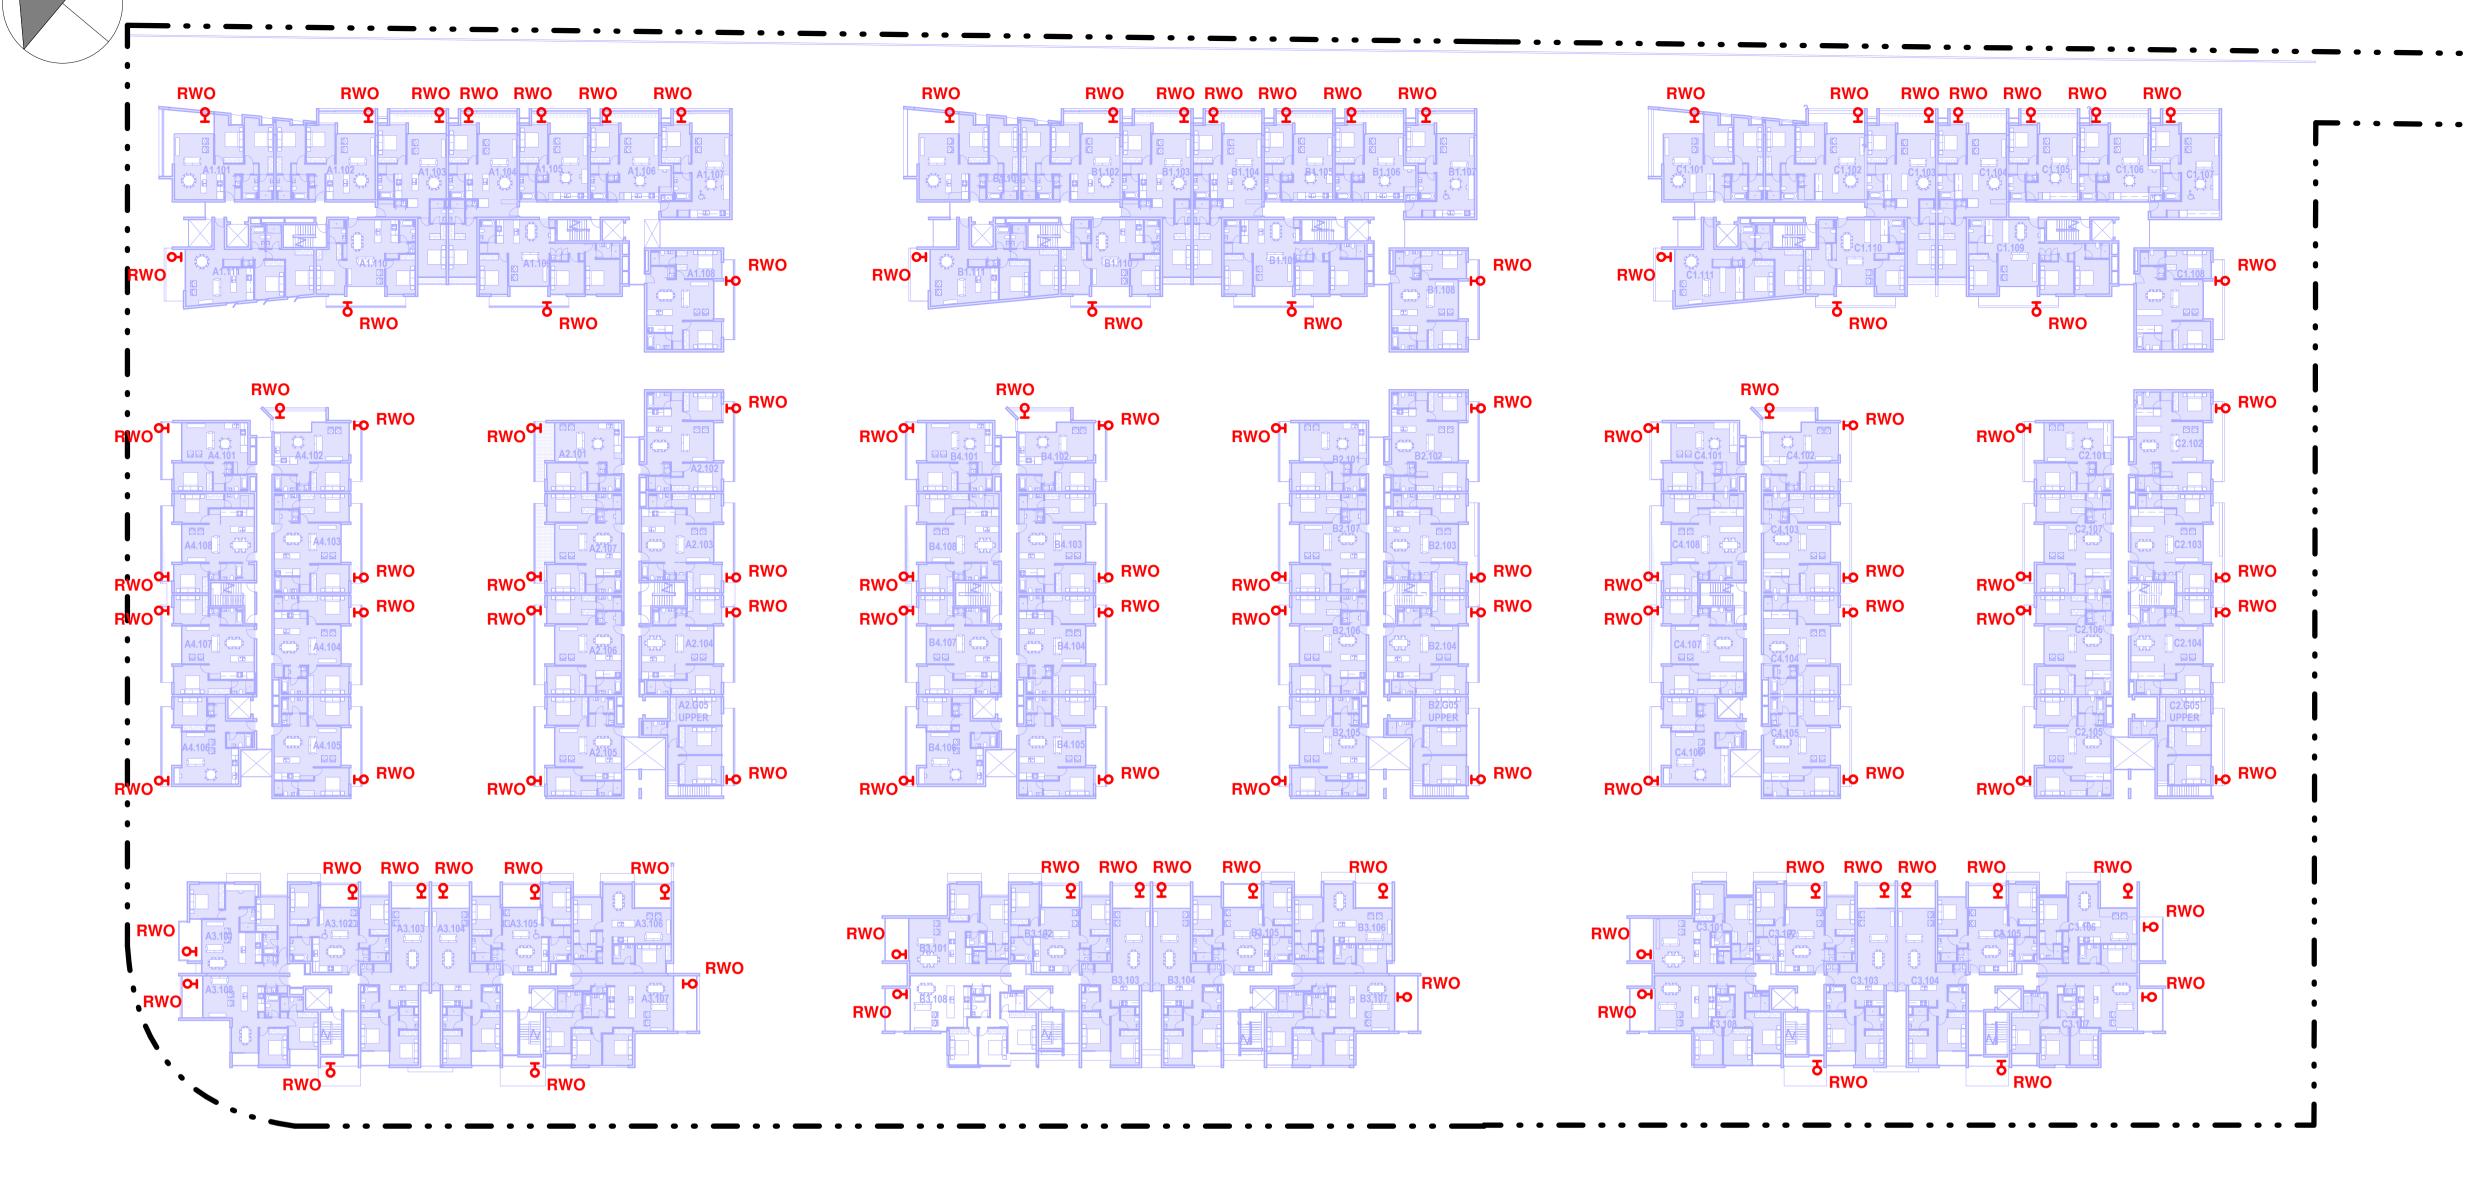
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STORMWATER CONCEPT PLAN - TYPICAL LEVEL

1:400

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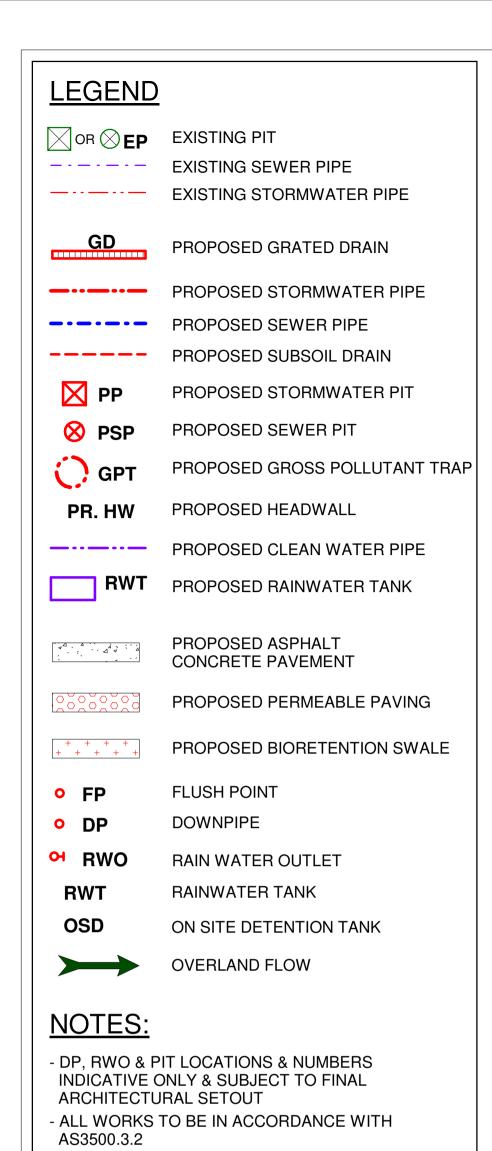
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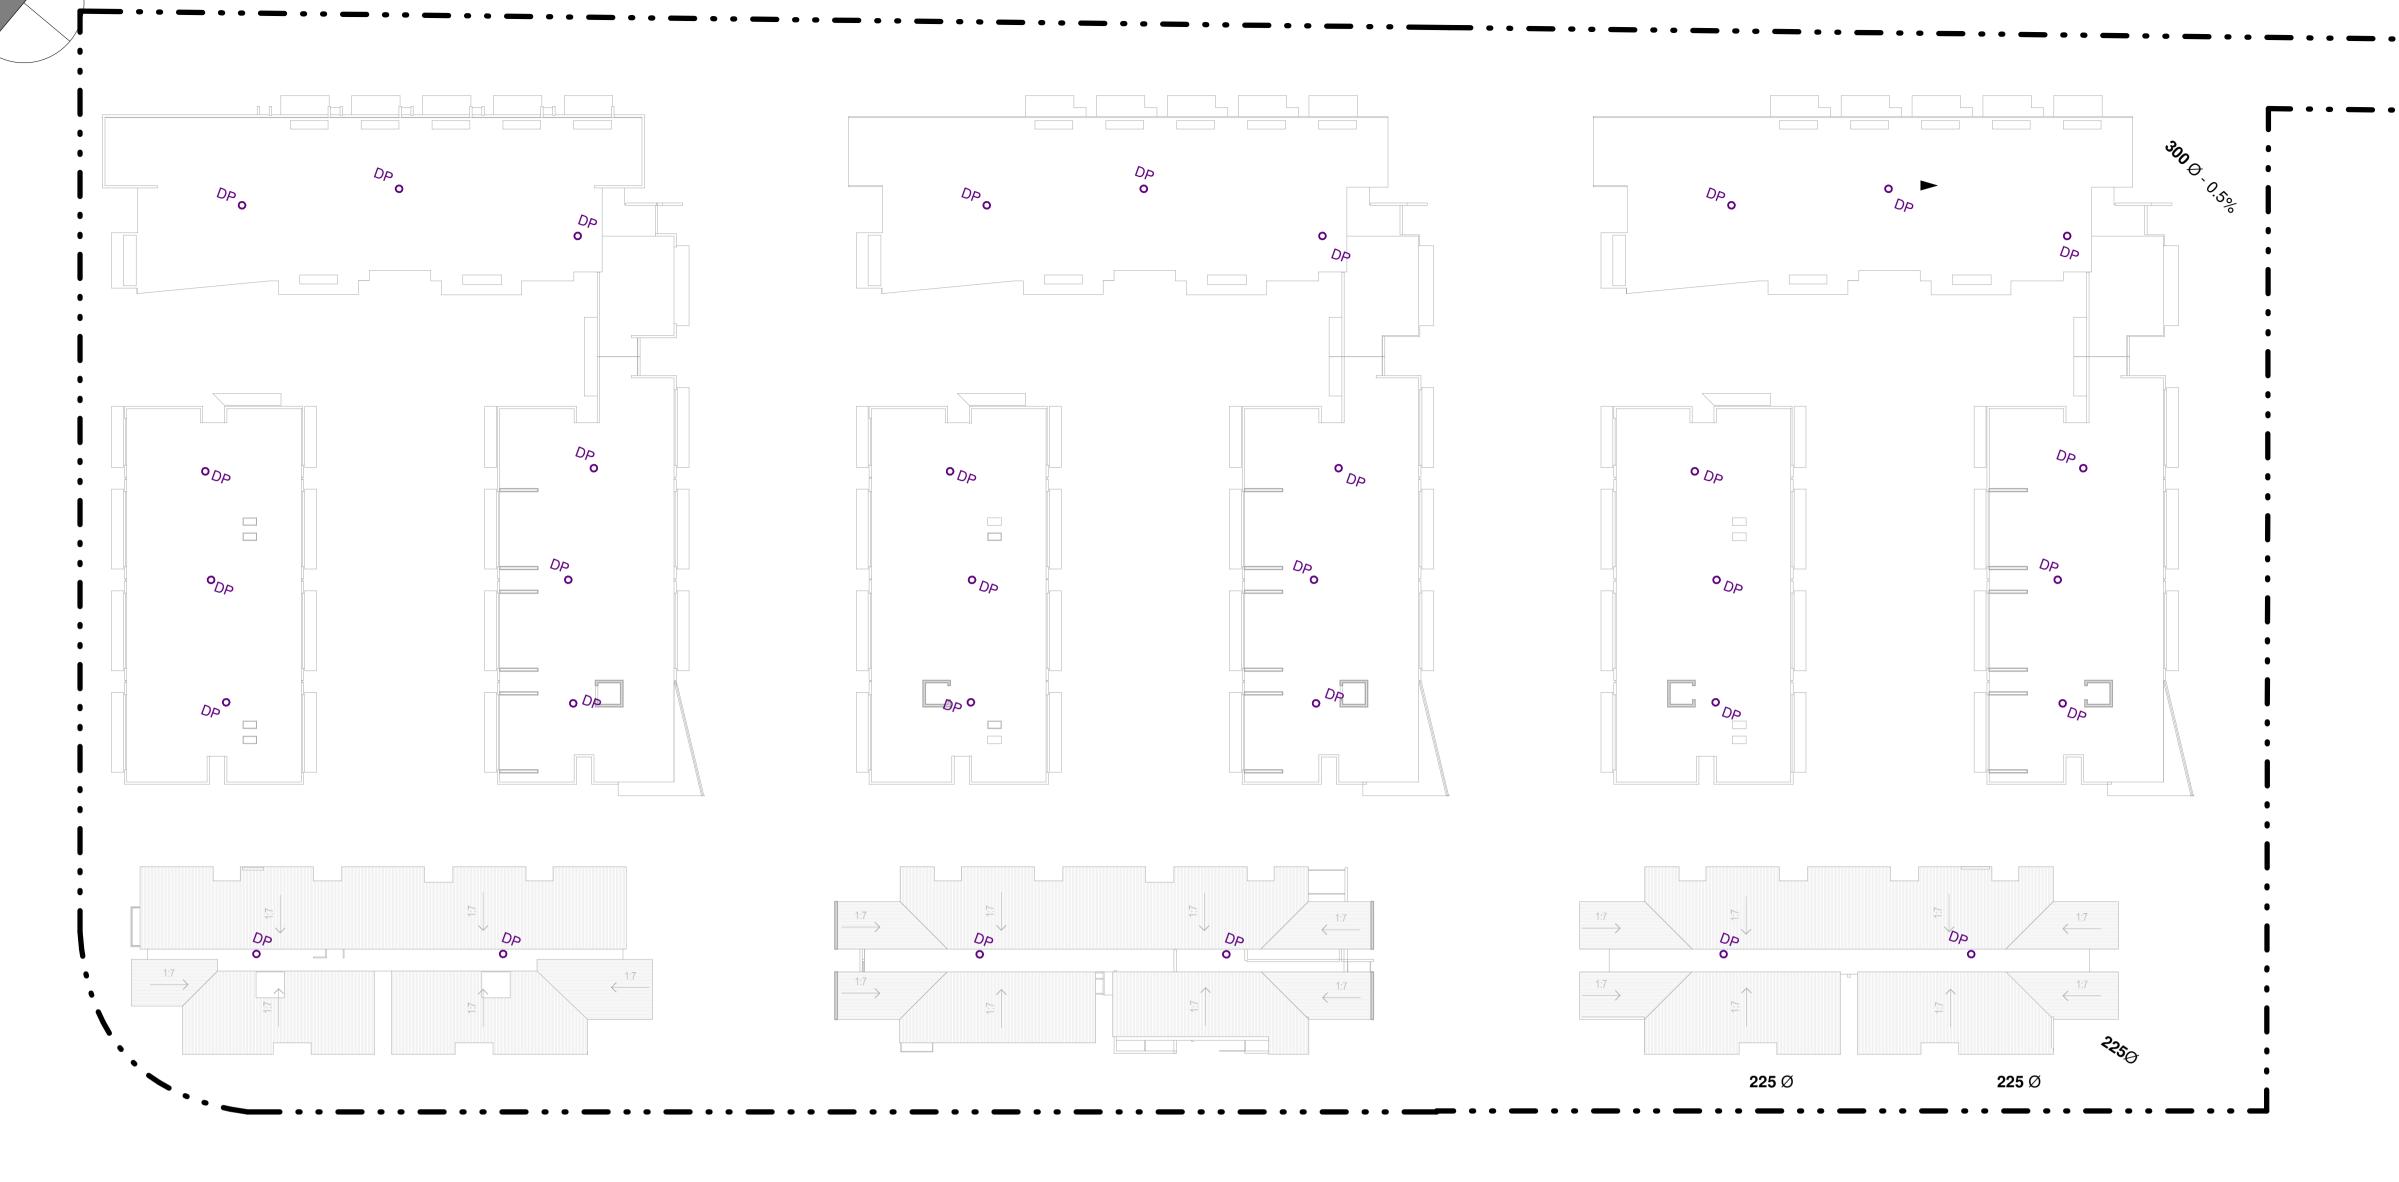
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STORMWATER CONCEPT PLAN - TYPICAL LEVEL

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		CHKD.			593	33
		APPRD.			DRAWING NO.	
	A1	SCALE As indicated	DATE N	MAY 2017	SW.17	В





STORMWATER CONCEPT PLAN - ROOF

1:400

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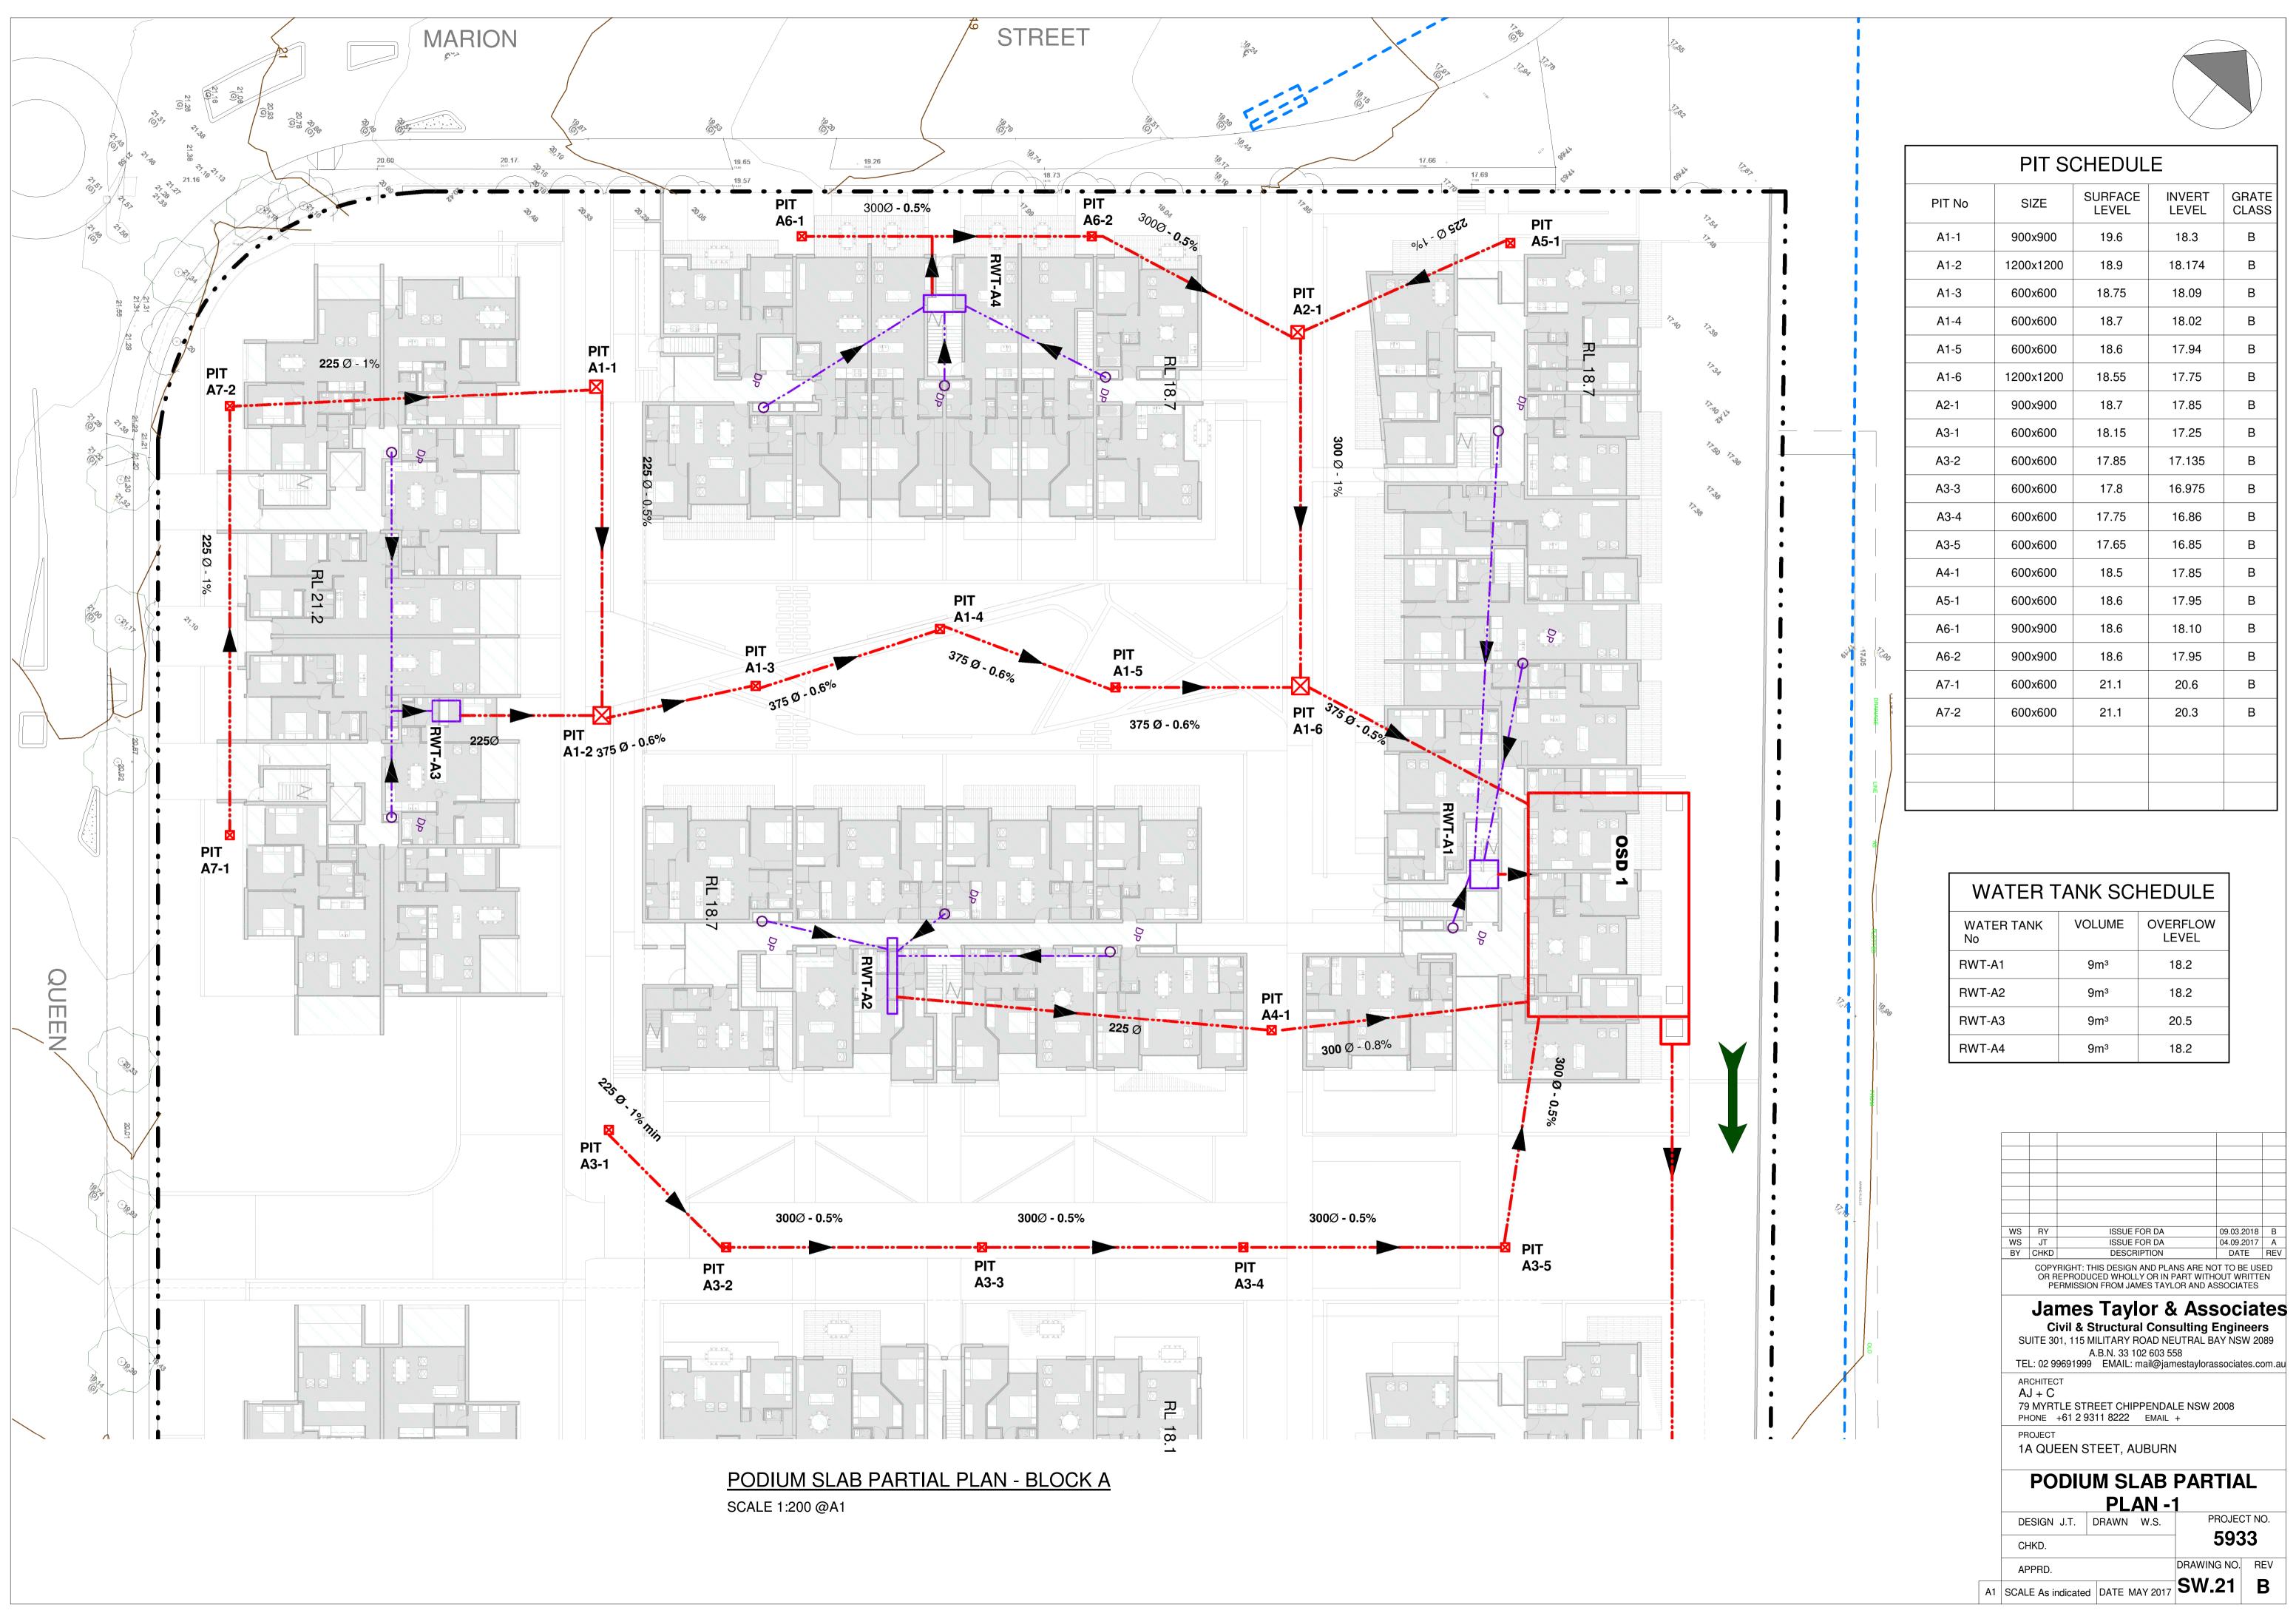
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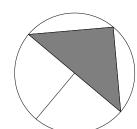
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STORMWATER CONCEPT PLAN - ROOF

DESIGN J.T. DRAWN W.S. 5933 DRAWING NO. REV

A1 SCALE As indicated DATE MAY 2017 SW.18 B





PIT SCHEDULE							
PIT No	SIZE	SURFACE LEVEL	INVERT LEVEL	GRATE CLASS			
A1-1	900x900	19.6	18.3	В			
A1-2	1200x1200	18.9	18.174	В			
A1-3	600x600	18.75	18.09	В			
A1-4	600x600	18.7	18.02	В			
A1-5	600x600	18.6	17.94	В			
A1-6	1200x1200	18.55	17.75	В			
A2-1	900x900	18.7	17.85	В			
A3-1	600x600	18.15	17.25	В			
A3-2	600x600	17.85	17.135	В			
A3-3	600x600	17.8	16.975	В			
A3-4	600x600	17.75	16.86	В			
A3-5	600x600	17.65	16.85	В			
A4-1	600x600	18.5	17.85	В			
A5-1	600x600	18.6	17.95	В			
A6-1	900x900	18.6	18.10	В			
A6-2	900x900	18.6	17.95	В			
A7-1	600x600	21.1	20.6	В			
A7-2	600×600	21.1	20.3	В			

WATER TANK SCHEDULE							
WATER TANK No	VOLUME	OVERFLOW LEVEL					
RWT-A1	9m³	18.2					
RWT-A2	9m³	18.2					
RWT-A3	9m³	20.5					
RWT-A4	9m³	18.2					


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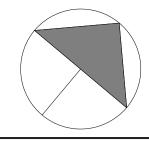
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PIT SCHEDULE								
PIT No	SIZE	SURFACE LEVEL	INVERT LEVEL	GRATE CLASS				
B1-1	900x900	18.1	17.59	В				
B1-2	1200x1200	18.05	17.374	В				
B1-3	900x900	17.95	17.29	В				
B1-4	900x900	17.90	17.22	В				
B1-5	900x900	17.85	17.14	В				
B1-6	1200x1200	17.8	17.05	В				
B2-1	900x900	18.1	17.4	В				
B3-1	900x900	17.40	16.9	В				
B3-2	900x900	17.35	16.85	В				
B3-3	900x900	17.30	16.75	В				
B3-4	900x900	17.25	16.65	В				
B3-5	900x900	17.15	16.55	В				
B4-1	900x900	17.70	17.1	В				
B5-1	600×600	19.0	18.4	В				
B5-2	600×600	19.0	18.1	В				
O-1	1500x1500	16.8 tbc	15.25 tbc	В				
O-1A	1000x3000	17.9	15.35	В				

WATER TANK SCHEDU					
WATER TANK No	VOLUME	OVERFLOW LEVEL			
RWT-B1	9m³	17.4			
RWT-B2	9m³	17.4			
RWT-B3	9m³	18			
RWT-B4	9m³	17.4			

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ARCHITECT AJ + C


79 MYRTLE STREET CHIPPENDALE NSW 2008 PHONE +61 2 9311 8222 EMAIL +


1A QUEEN STEET, AUBURN

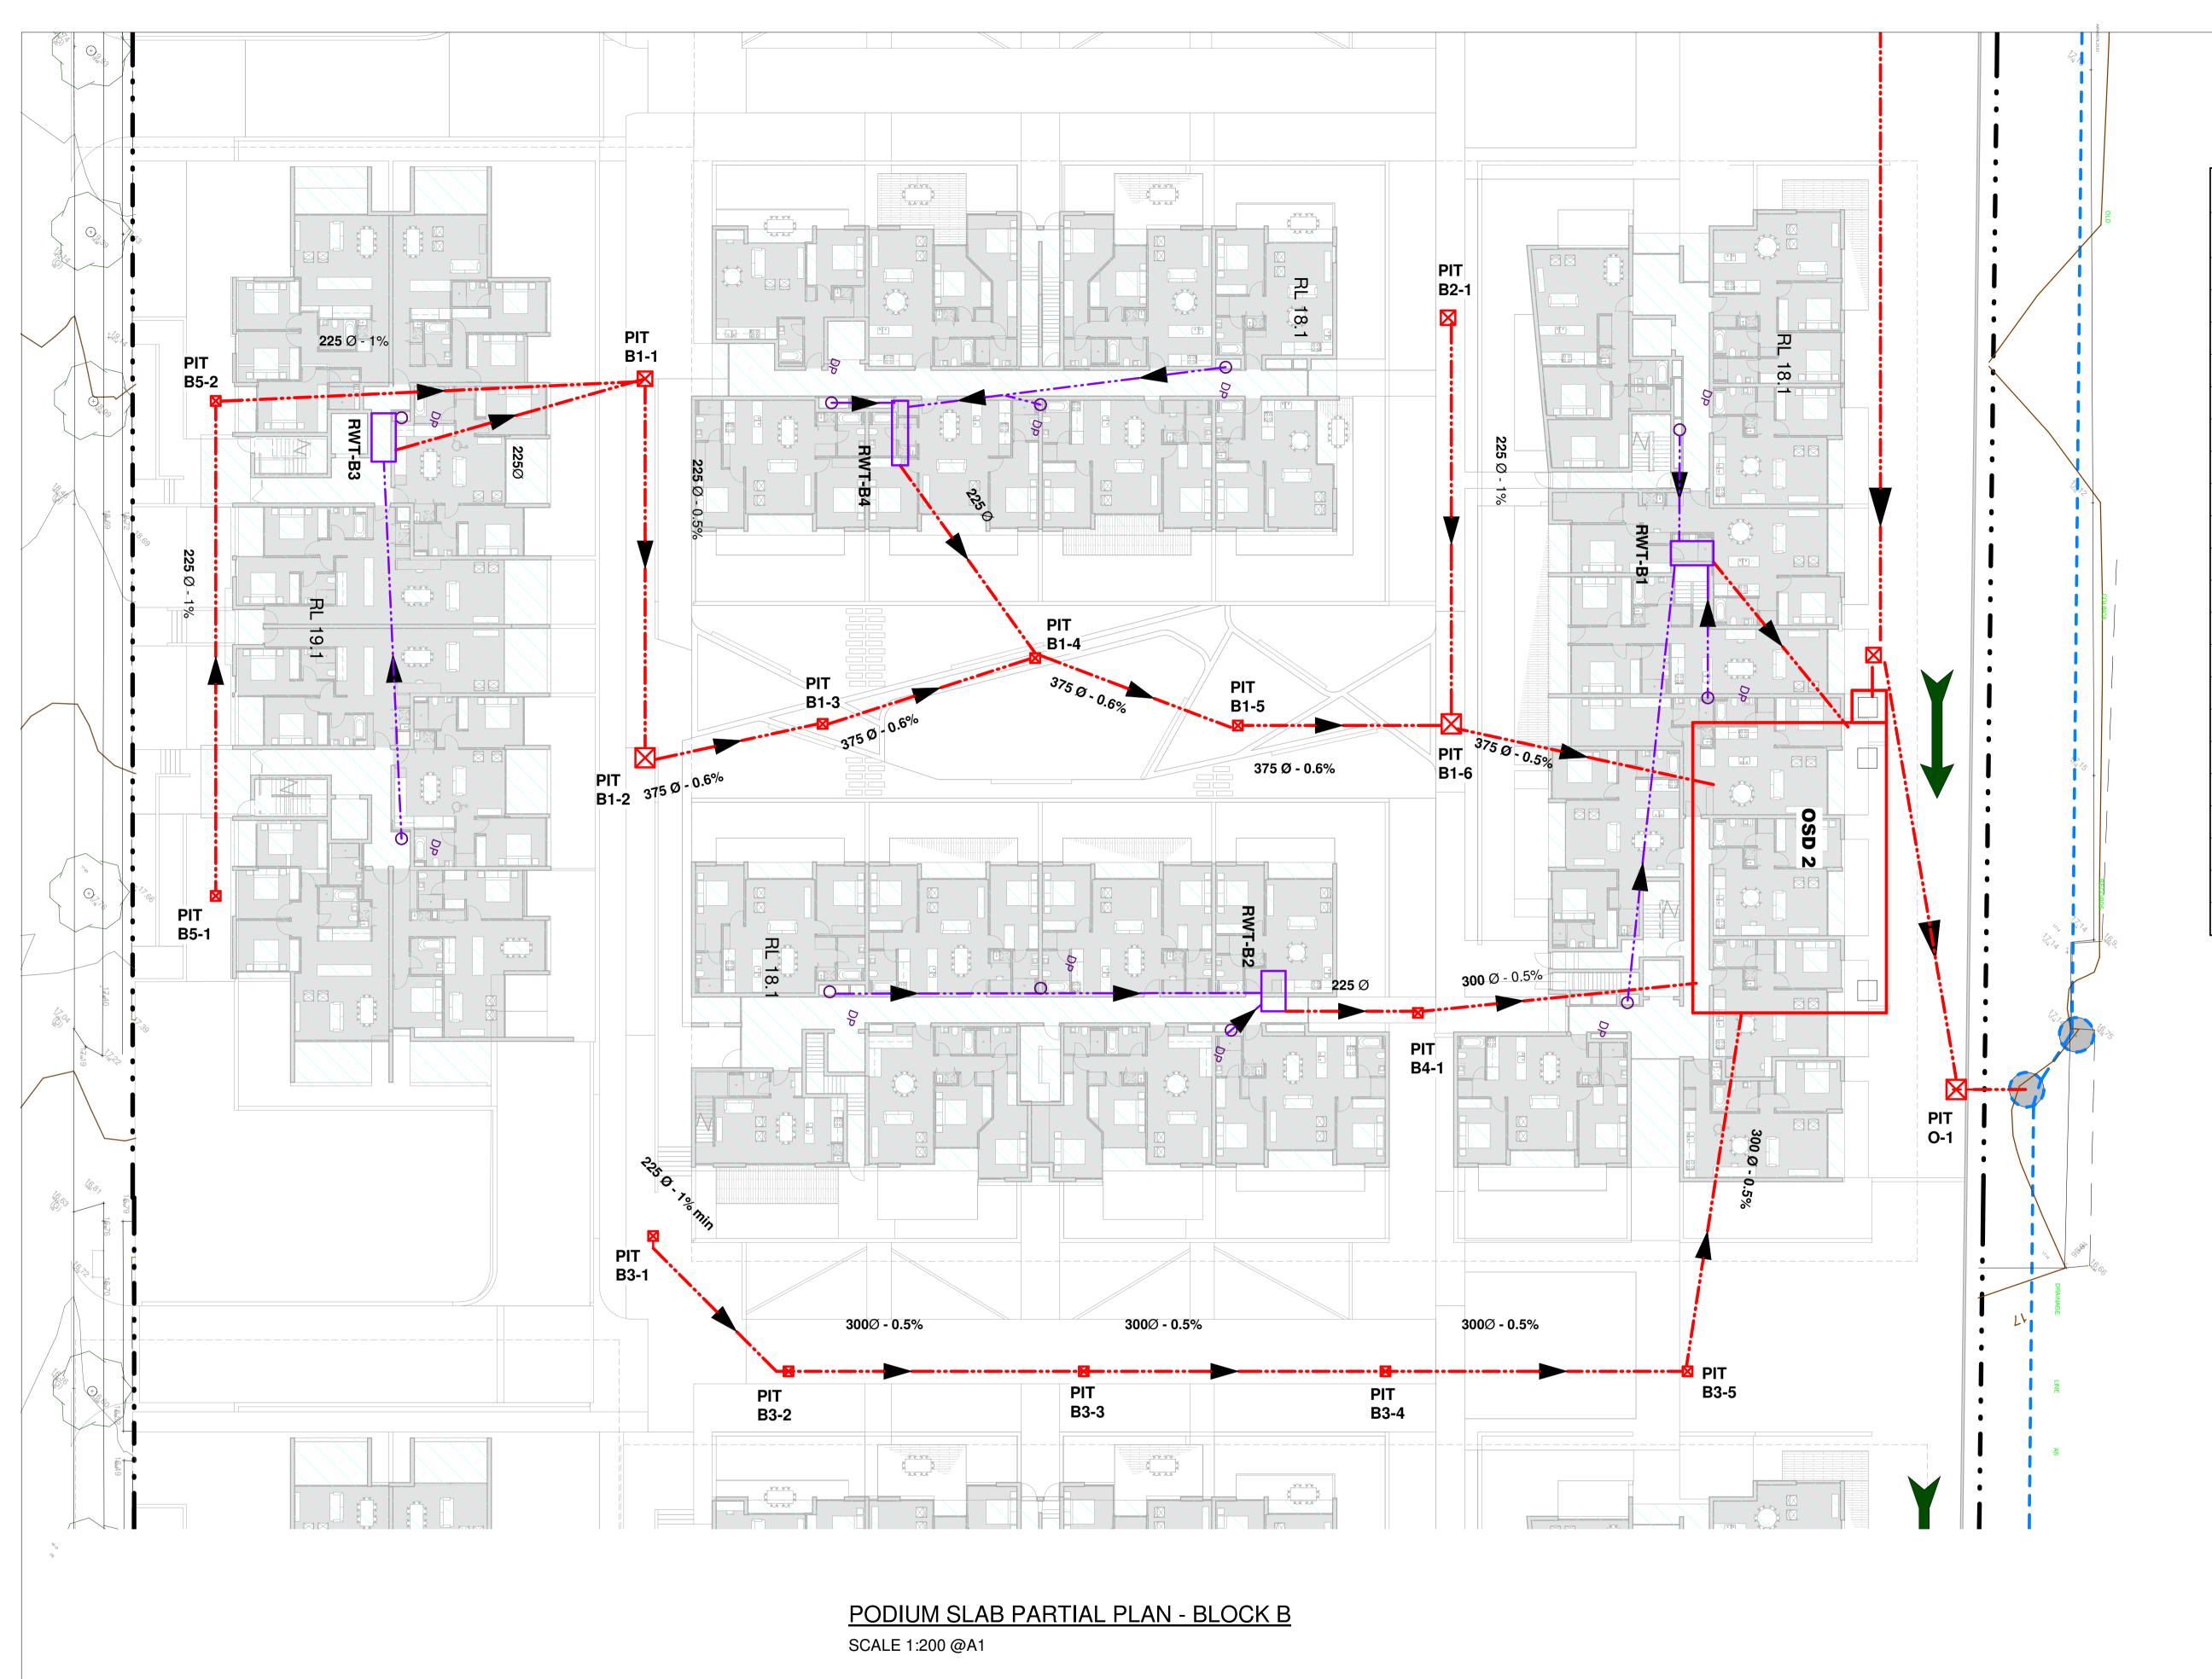PODIUM SLAB PARTIAL DI ANI O

PLAN -2				
DESIGN J.T.	DRAWN W.S.	PROJEC	CT NO.	
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CHKD.			593	ာ
APPRD.			DRAWING NO.	REV

A1 SCALE As indicated DATE MAY 2017 SW.22 B

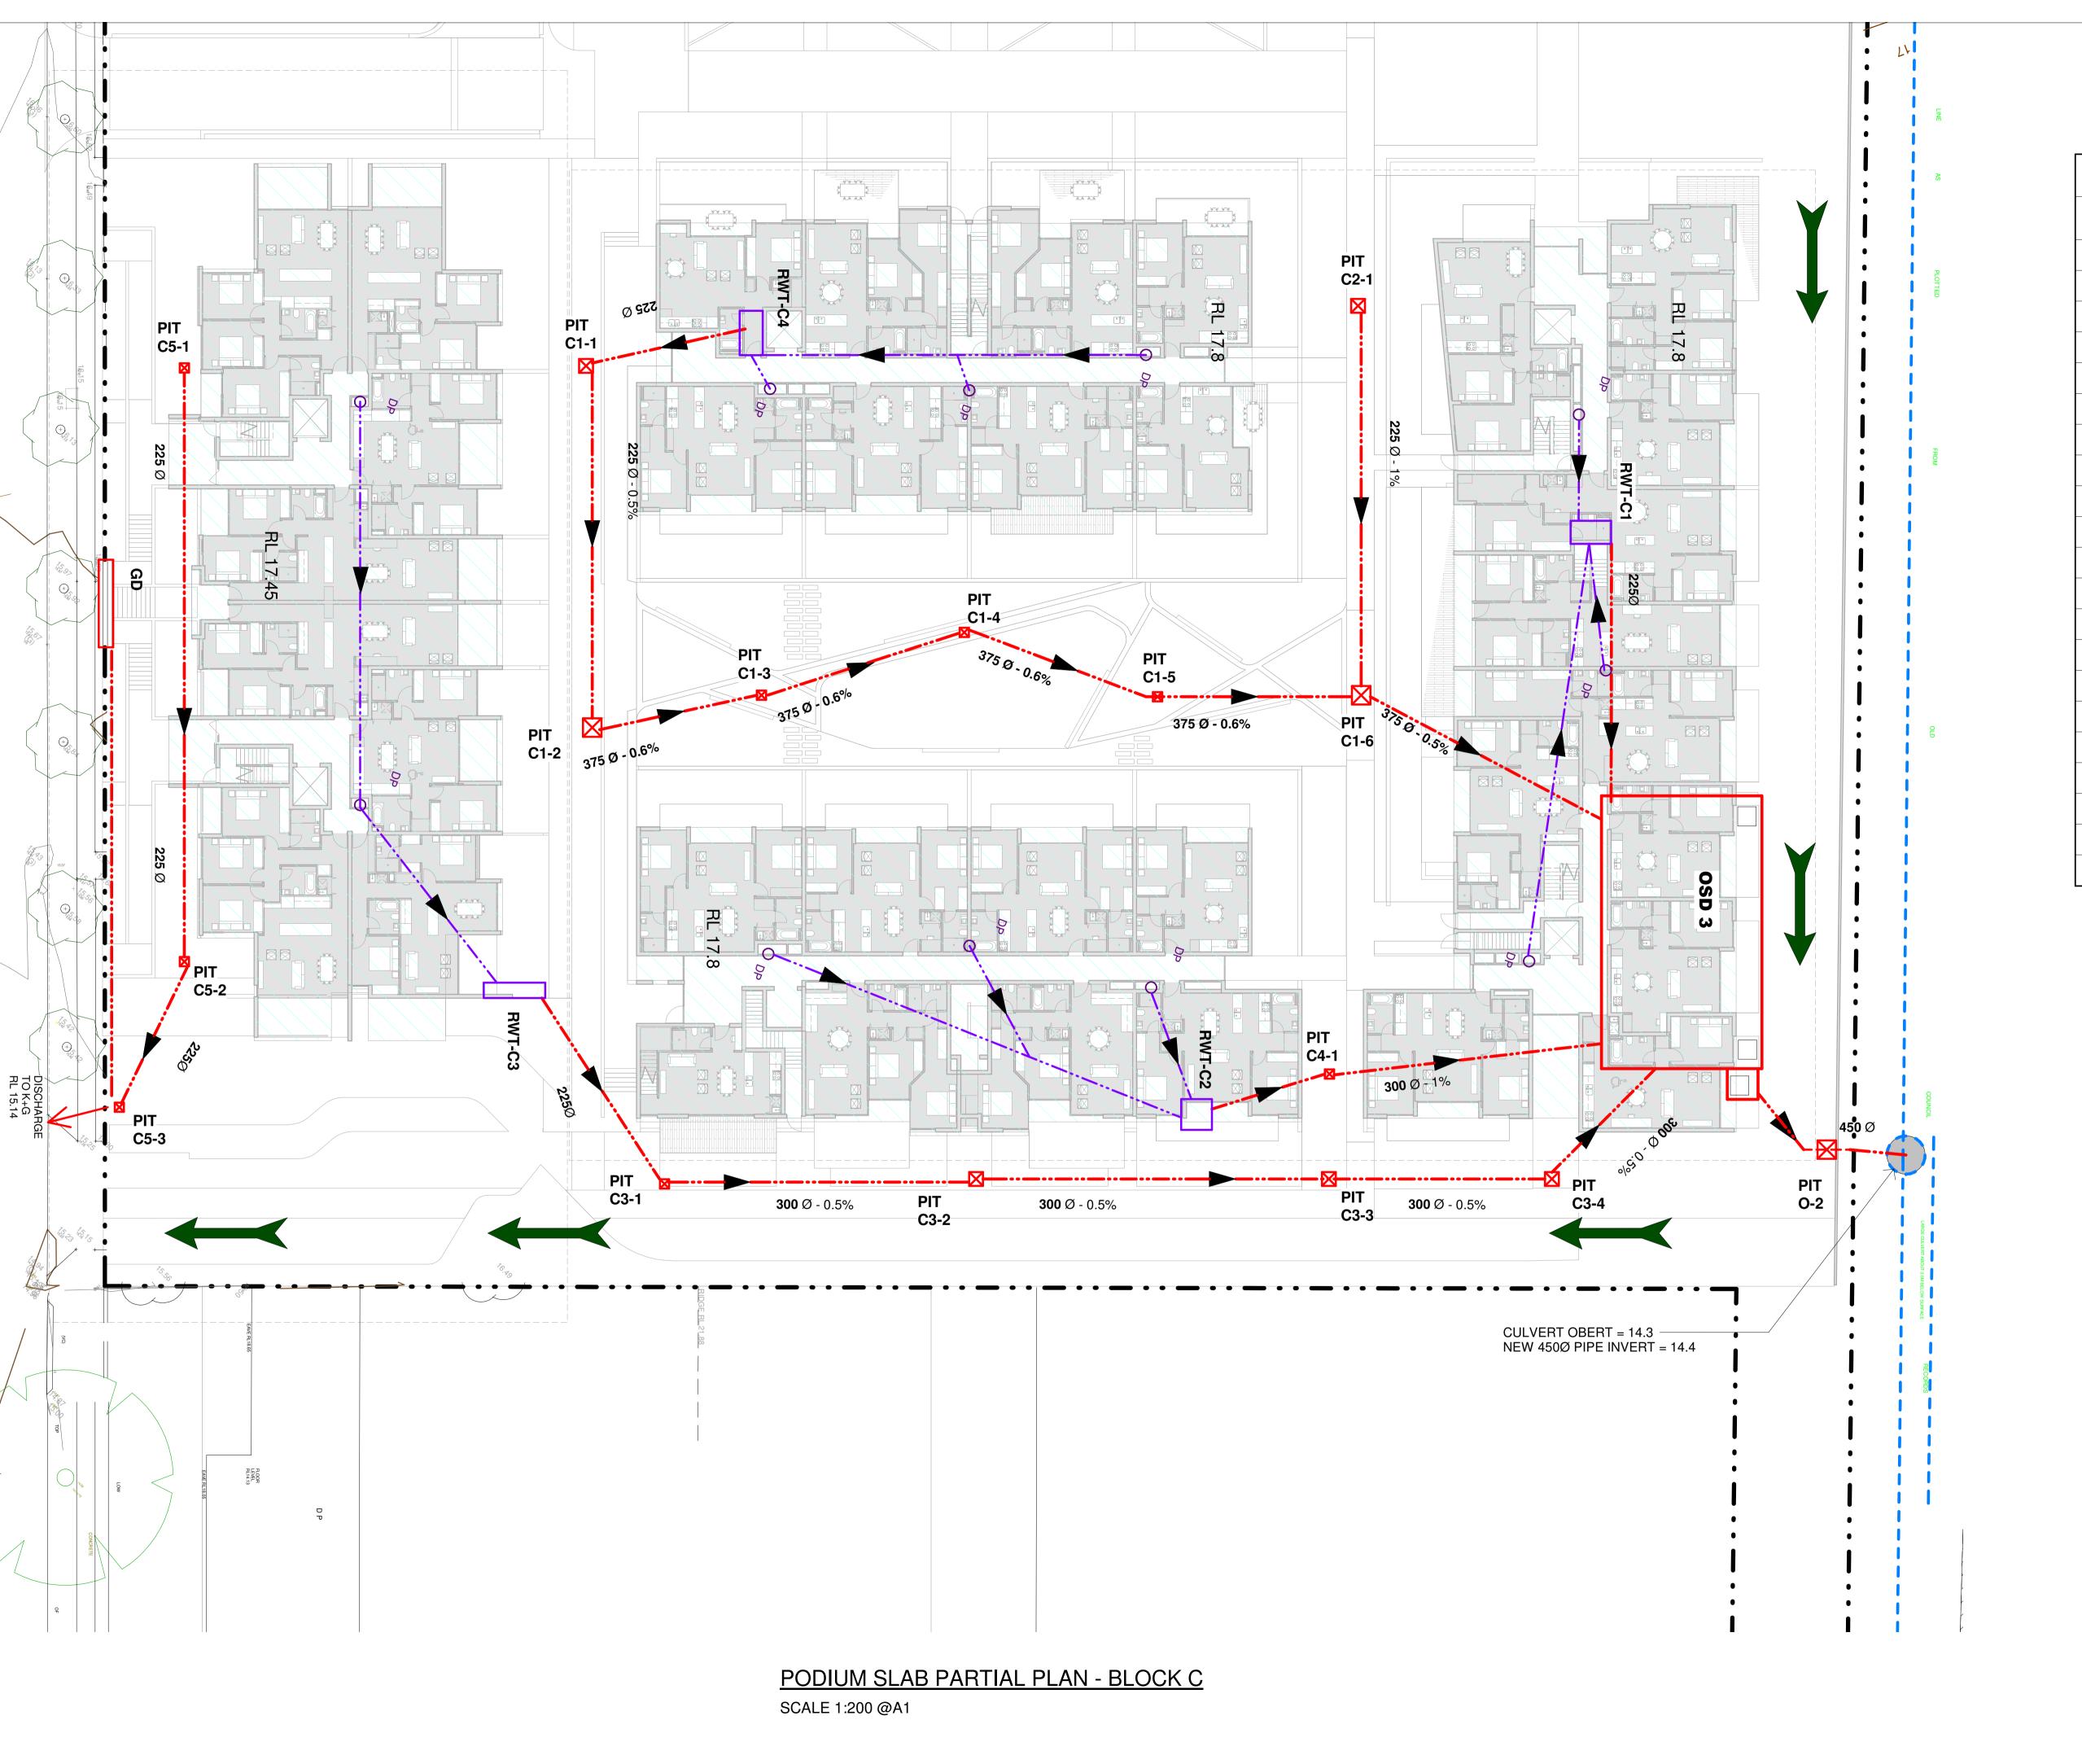

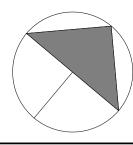

PIT SCHEDULE							
PIT No SIZE SURFACE INVERT GRATE CLASS							
C1-1	900×900	17.80	17.08	В			
C1-2	900x900	17.78	16.955	В			
C1-3	600x600	17.70	16.87	В			
C1-4	600×600	17.70	16.80	В			
C1-5	600×600	17.70	16.72	В			
C1-6	1200x1200	17.70	16.53	В			
C2-1	900x900	17.80	17.08	В			
C3-1	600x600	17.50	16.8	В			
C3-2	600x600	17.50	16.7	В			
C3-3	600x600	17.50	16.59	В			
C3-4	600x600	17.50	16.52	В			
C4-1	600x600	17.55	16.90	В			
C5-1	600×600	17.35	16.90	В			
C5-2	600×600	17.35	16.7	В			
C5-3	600x600	15.40	15.15	В			
O-2	1500x1500	16.1	14.65	В			

WATER TANK SCHEDULE				
WATER TANK No	VOLUME	OVERFLOW LEVEL		
RWT-C1	9m³	17.3		
RWT-C2	9m³	17.3		
RWT-C3	9m³	16.9		
RWT-C4	9m³	17.3		

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BY	CHKD	DESCRIPTION	DATE	REV	
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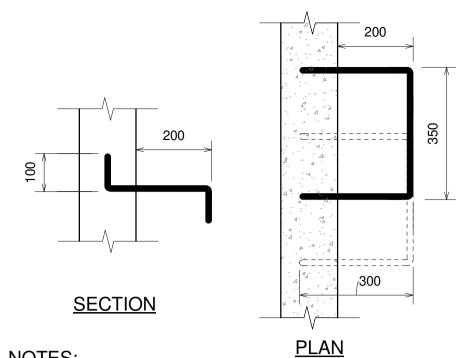
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1A QUEEN STEET, AUBURN

PODIUM SLAB PARTIAL PLAN -3

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DESIGN J.T.	DRAWN	W.S.	PROJEC	CT NO.
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A1 SCALE As indicated DATE MAY 2017 SW.23 B




NOTES:

- 1. WHEN POSITIONING IN STRAIGHT ALIGNMENT,
- STEP TO BE 400 WIDE.
- 2. STAGGERED STEPS TO BE 300 WIDE, STEPS TO BE STAGGERED 300 CENTRE TO CENTRE FOR ALTERNATE
- STEPS WITH MINIMUN 45 OVERLAP.
- 3. SPACING TO BE UNIFORM TO WITHIN +-8mm IN EACH PIT.
- 4. STEP IRONS TO BE H.D. GALVANIZED AFTER FABRICATION IN ACCORDANCE WITH LOCAL GOVERNMENT'S CODES & REQUIREMENTS

STEP IRONS

NOT TO SCALE

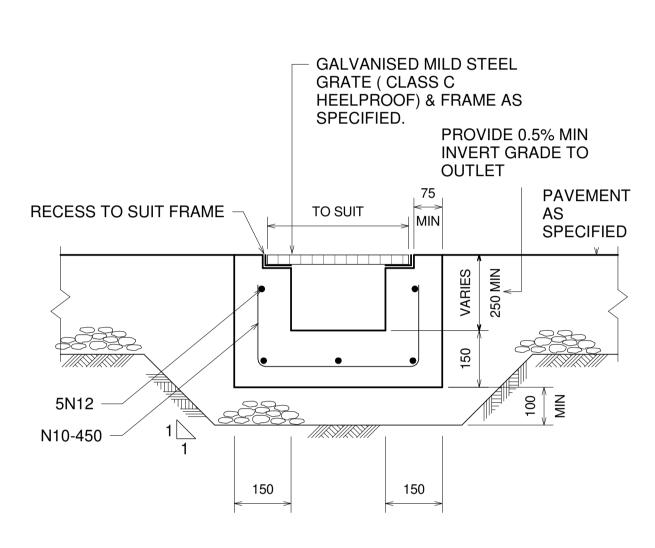


CONFINED SPACE WITHOUT CONFINED SPACE


CONFINED **SPACE SIGN** NOT TO SCALE




RAINWATER SIGN NOT TO SCALE

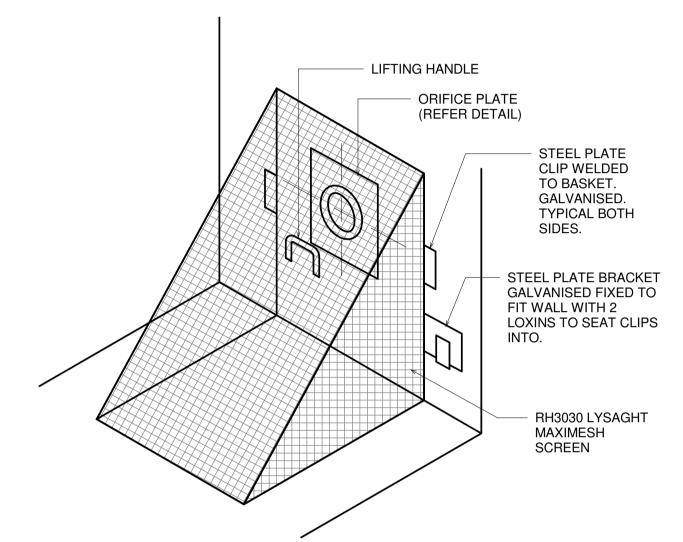



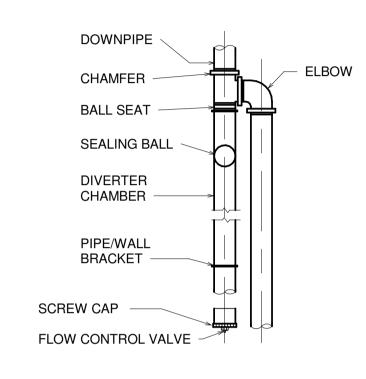


FIRST FLUSH DIVERTER

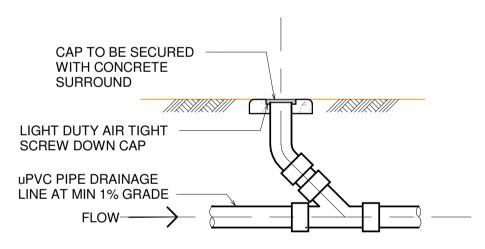

GRATED DRAIN PAVEMENT

SCALE 1:10

CROSS FALL

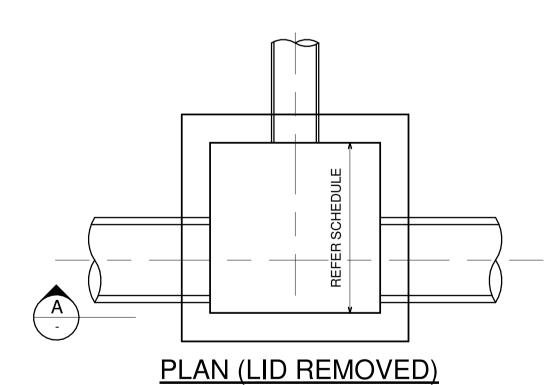

GRATED LID REFER

LID TYPES

REFER SCHEDULE

SECTION A

75 <->


INVERT

FINISHED SURFACE LEVEL

NOTES

- 1. CONCRETE STRENGTH N25.
- SIDE DIMENSIONS WILL VARY SUBJECT TO PIPE SIZE. SIDE DIMENSIONS ARE DETERMINED BY LARGEST OUTSIDE PIPE DIMENSIONS PLUS 200.
 PIT DIMENSIONS ARE ALSO GOVERNED BY THE DEPTH OF THE PIT. PLEASE REFER
- TO POINT (h). PAGE A7-2. WATER MANAGEMENT DEVELOPMENT CONTROL PLAN-DCP 47. APPENDIX 7 - DESIGN OF PROPERTY AND INTERALLOTMENT DRAINAGE
- SYSTEMS. KU-RING-GAI COUNCIL.
 4. REINFORCEMENT IN WALLS/SLAB TO BE IN ACCORDANCE WITH LOCAL
- GOVERNMENT'S CODES & REQUIREMENTS 5. UNLESS NOTED OTHERWISE, PROVIDE ENVIROPODS TO ALL GRATED PITS.

CLEANING EYE NOT TO SCALE

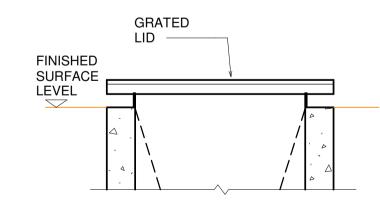


N.T.S.


TYPE A


LID

SURFACE LEVEL

ENVIROPOD TO MANUFACTURER'S SPECIFICATIONS. REFER NOTES. TYPICAL.

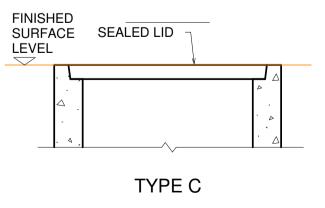

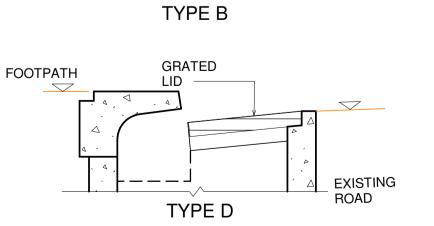

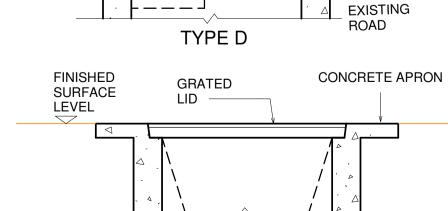

REINFORCEMENT DETAIL

PIT LID TYPES

TYPE E

ISSUE FOR DA 09.03.2018 B ISSUE FOR DA 04.09.2017 A DESCRIPTION DATE REV

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1A QUEEN STEET, AUBURN

STORMWATER SECTIONS & DETAIL & CHEET 1

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	CHKD.			593	33
	APPRD.			DRAWING NO.	
A1	SCALE As indicated	DATE	MAY 2017	SW.40	В